

GENESEE COUNTY PLANNING BOARD REFERRALS

HOLLAND LAND OFFICE	NOTICE OF FINAL ACTION
1802	GCDP Referral ID T-01-LEROY-2-22
VOI TO	Review Date 2/10/2022
Municipality	LEROY, T.
Board Name	PLANNING BOARD
Applicant's Name	Jeff Cook, NYS Rt. 5 SelfStorage, LLC
Referral Type	Special Use Permit
Variance(s)	
Description:	Special Use Permit and Site Plan Review to construct four additional 6,000 sq. ft. (30 x 200 ft.) storage buildings at an existing self-storage facility.
Location	7054 W. Main Rd. (NYS Rt. 5), LeRoy
Zoning District	Industrial (I-1) District
PLANNING BOARD	DECISION
APPROVAL WITH M	ODIFICATION(S)
EXPLANATION:	

The required modifications are as follows: 1) Given that the project will disturb more than one acre of land, the applicant completes a Stormwater Pollution Prevention Plan (SWPPP) and obtains a Stormwater Permit for Construction Activity from DEC prior to final approval from the Town; and 2) Given that the Short Environmental Assessment Form (EAF) states that the project is located in an archaeological sensitive area, the applicant obtain documentation from the State Historic Preservation Office (SHPO) as to the project's impacts on archaeological resources. With these required modifications, the proposed additions to this self-storage facility should pose no significant county-wide or inter-community impact.

February 10, 2022

If the County Planning Board disapproved the proposal, or recommends modifications, the referring agency shall NOT act contrary to the recommendations except by a vote of a majority plus one of all the members and after the adoption of a resolution setting forth the reasons for such contrary action. Within 30 days after the final action the referring agency shall file a report of final action with the County Planning Board. An action taken form is provided for this purpose and may be obtained from the Genesee County Planning Department.

SEND OR DELIVER TO:

GENESEE COUNTY DEPARTMENT OF PLANNING 3837 West Main Street Road

Address, City, State, Zip 48 Main St LeRoy, NY 14482

Batavia, NY 14020-9404 Phone: (585), %!+\$%

Clear Form

DEPARTMENT USE ONLY:

Email apodolak.code@leroyny.org

GCDP Referral # T-01-LEROY-2-22



* GENESEE COUNTY * PLANNING BOARD REFERRAL

RECEIVED Genesee County Dept. of Planning 01/12/2022

Required According to:

GENERAL MUNICIPAL LAW ARTICLE 12B, SECTION 239 L, M, N

W YOL	(Please answer ALL questions	as fully as possible)	, ,	
1. <u>Referring Board(s) Informa</u>	TION 2. APPLICAN	T INFORMATION		
Board(s) LeRoy Planning Board	Name Jeff C	ook, NYS Rt. 5 Sel	fStorage, LLC	
Address 48 Main St.	Address <u>90 A</u>	irpark Drive, Suite	400	
City, State, Zip LeRoy, New York 14	482 City, State, Zij	Rochester, New	York 14624	
Phone (<u>585</u>) 768 - 6910	Ext. 223 Phone (585) 233	-4699 Ext.	Email jeffcook@c	cookpropertiesny.
MUNICIPALITY: City	Town Village of Le	Roy		
3. TYPE OF REFERRAL: (Check all app	licable items)			
☐ Area Variance ☐ Use Variance ☐ Special Use Permit ☐ Site Plan Review 4. LOCATION OF THE REAL PROPE	Zoning Map Change Zoning Text Amendments Comprehensive Plan/Updat Other:	e Preli	sion Proposal iminary l	
A. Full Address 7054 West Main		FERRAL.		
B. Nearest intersecting road Keene				_
C. Tax Map Parcel Number 291-				
D. Total area of the property 7 acr		operty to be disturbed	2 acres	
E. Present zoning district(s) I-1			`-	
5. REFERRAL CASE INFORMATION: A. Has this referral been previously	_	Planning Board?		
■ NO YES If yes, give d	ate and action taken			
B. Special Use Permit and/or Varian	nces refer to the following section(s) of the present zoni	ng ordinance and/o	or law
165-20, Section C, number 5				
C. Please describe the nature of this			zone C-2 and one	e unit within
the I-1, property owner wants t	o build four additional units on	land zoned I-1.		
6. ENCLOSURES – Please enclose copy Local application Site plan Subdivision plot plans SEQR forms	(s) of all appropriate items in regar Zoning text/map amendment Location map or tax maps Elevation drawings Agricultural data statement	<u></u>	updated comprehe	nsive plan
7. <u>CONTACT INFORMATION</u> of the pe	rson representing the community in Title CEO	in filling out this form Phone (585)	` *	ion) Ext. 225
Tame / Tillo I Goodan		1 110110 (000)	700 0010	11AL. 22 U

Town of LeRoy

James R. Farnholz Supervisor

Patricia A. Canfield Town Clerk/Tex Collector

Darryl Sehm John Duyssen Town Justices



Dave Paddock Deputy Supervisor

John Armitage John Johnson Ron Pangrazio Town Council

Eric Stauffer Supr. of Highways

APPLICATION FOR SITE PLAN REVIEW

PROPERTY INFORMATION	ON
ADDRESS: 7054 West Main Road	
ZONING CLASSIFICATION: C-2 + I-1 Tax Map ID #_	29.00-1-12.2+29.00-1-12.12
PRESENT USE OF PROPERTY: Commercial - Sel	
PROPOSED USE OF PROPERTY: Commercial - 156	
PROPOSAL DESCRIPTION (Include # of employees	, hours of operation, and description of
business. If there is new construction, please provide a de	tailed description):
Construction of an additional-	four Single Story Self
Storage buildings, stone pave	ments and a stormulate
pond within the existing Ro	vite 5 Sturage facilities
partie toterten in casine in	ibit i giaraje raciticy.
ADDITIONAL CONTACT INFORMATION NAME.	
APPLICANT CONTACT INFORMATION NAME:	11/ 105-222 11108
NAME: Jeff Cook - NYS RIS Self Sturage 1	
ADDRESS: 90 Airour Drive Ste 400, Roch	lester, NY ZIP: 14624
EMAIL: jet cook@ cookproperties my, com	
PROPERTY OWNER CONTACT INFORMATION (IF DIFFERE	NT FROM APPLICANT)
1	
NAME:	PHONE:
ADDRESS:	ZIP:
2 //	
SIGNATURE OF THE PROPERTY OWNER IS REQUIRED FOR I	REVIEW OF YOUR PROPOSAL:
	Application Fee 100.00
Code Enforcement Officer Signature:	Date rec'd
Clerk's Signature:	Ck $N_{\rm O}$

TOWN/VILLAGE of LEROY Application

SPECIAL USE PERMIT #
Applicant: NTS Rt 5 Self Strage LLC Date Received: Address: 90 August Dr. Ste 400 Date advertised: Rochester, NY 14624 Date of Hearing:
Phone # 585-233-4699 SBL # 29.00-1-12.2+ 29.00-1-12.
Fee: \$250.00 (R+A Zones) \$200.00 (all other zones)
Decision
I hereby apply for a Special Use to: Expand the existing Route 5 Storage facility to include new self storage buildings in the I-1 Industrial District.
Reasons for proposed change of present status: 1] It is proposed to expand the existing Route S Storage facilit
The parcel configuration allows no choice but to expand into
the I-I Industrial District.
2]
If additional information is necessary, use reverse side and so indicate
Signature of Applicant: Date: 107
Signature of CEO
Amt. Rec'd Ck. # Date rec'd By Town Clerk
Revision 4-2015

TOWN VILLAGE CITY OF LE	ROY Application #
Agricultural Data Stater	nent Date

varia	nce or a subdivision approval requiring	cation for a special use permit, site plan approval, use g municipal review that would occur on property within 500 lept. of Ag & Markets certified Agricultural District.
	Applicant	Owner if Different from Applicant
Name: Jeff Co. Address: 90 A. Rounes	ok NYS Route 5 Self Strange coark Dr. Ste 400 LIC ter. NY 14624	Name:Address:
(circle one or mo	ation: Special Use Permit; Site Subdivision Approval proposed project: Construction Proposed Stone Pare Stone Pare	Plan Approval : Use Variance; of an additional four single story rements, and a stormwater point rage facility.
3. Location of proj4. Is this parcel wi5. If YES, Agriculto6. Is this parcel ac	ect: Address: 7054 West M Tax Map Number (TMP) 29. thin an Agricultural District? No ural District Number 3 tively farmed?	an Road, Leroy, NY 14482
Name: James Address: West Lero Is this parcel act	Main Road y, Ny 14482	Name: Route 5 Storage LLC Address: West Main Read Leroy NY 14482 Is this parcel actively farmed? NO XYES
Name: John Address: West Lero Is this parcel acti		Name: Route 5 Storage LLC Address: West Main Road Leroy, NY 14482 Is this parcel actively farmed? NO XYES
Signati	ure of Applicant	Signature of Owner (if other than applicant)
Reviewed by:	Signature of Municipal Official	Date
		ning Board review is required. A copy of the with the referral to the County Planning Department.

Short Environmental Assessment Form Part 1 - Project Information

Instructions for Completing

Part 1 – Project Information. The applicant or project sponsor is responsible for the completion of Part 1. Responses become part of the application for approval or funding, are subject to public review, and may be subject to further verification. Complete Part 1 based on information currently available. If additional research or investigation would be needed to fully respond to any item, please answer as thoroughly as possible based on current information.


Complete all items in Part 1. You may also provide any additional information which you believe will be needed by or useful to the lead agency; attach additional pages as necessary to supplement any item.

Part 1 – Project and Sponsor Information			
Name of Action or Project:			
Route 5 Storage Expansion			
Project Location (describe, and attach a location map):			
7054 West Main Road, Town of Leroy, NY			
Brief Description of Proposed Action:			
Construction of an additional four single story self storage buildings, stone pavements, and a facility.	stormwater pond within the ex	xisting Route 5 Storage	
Name of Applicant or Sponsor:	Telephone: 585-233-4699	9	
Jeffrey Cook, NYS Route 5 Self Storage LLC E-Mail: jeffcook@cookpropertiesny		opertiesny.com	
Address:			
90 Airpark Drive, Suite 400			
City/PO: State: Zip Code:			
Rochester NY 14624			
 Does the proposed action only involve the legislative adoption of a plan, local administrative rule, or regulation? 	al law, ordinance,	NO YE	S
If Yes, attach a narrative description of the intent of the proposed action and the emay be affected in the municipality and proceed to Part 2. If no, continue to ques		at 🛭 🔽 🗎]
2. Does the proposed action require a permit, approval or funding from any other		NO YE	S
If Yes, list agency(s) name and permit or approval: NYSDEC SPDES permit	g		_
3. a. Total acreage of the site of the proposed action? b. Total acreage to be physically disturbed? c. Total acreage (project site and any contiguous properties) owned or controlled by the applicant or project sponsor?	7.0 acres 2.2 acres 7.0 acres		
4. Check all land uses that occur on, are adjoining or near the proposed action:			
5. Urban Rural (non-agriculture) Industrial V Commercia	al 🗹 Residential (subur	tban)	
Forest Agriculture Aquatic Other(Spe	cify):		
Parkland			

5.	Is the proposed action,	NO	YES	N/A
	a. A permitted use under the zoning regulations?		V	
	b. Consistent with the adopted comprehensive plan?		V	
_	Title 1 1 1 1 1 1 1 1 1 1 1 1 1 1 1 1 1 1 1	2	NO	YES
6.	Is the proposed action consistent with the predominant character of the existing built or natural landscape	ſ		V
7.	Is the site of the proposed action located in, or does it adjoin, a state listed Critical Environmental Area?		NO	YES
If Y	Yes, identify:			
				V.E.C.
8.	a. Will the proposed action result in a substantial increase in traffic above present levels?		NO	YES
	b. Are public transportation services available at or near the site of the proposed action?		片	
	c. Are any pedestrian accommodations or bicycle routes available on or near the site of the proposed action?		V	
9.	Does the proposed action meet or exceed the state energy code requirements?		NO	YES
If t	he proposed action will exceed requirements, describe design features and technologies:		_	
==				
10.	Will the proposed action connect to an existing public/private water supply?		NO	YES
	If No, describe method for providing potable water:			
The	self storage buildings will not be supplied with water.			
-				
11.	Will the proposed action connect to existing wastewater utilities?		NO	YES
	If No, describe method for providing wastewater treatment:			
The	self storage buildings will not be supplied with wastewater facilities.			Ш
12.	a. Does the project site contain, or is it substantially contiguous to, a building, archaeological site, or distri	ct	NO	YES
	ich is listed on the National or State Register of Historic Places, or that has been determined by the mmissioner of the NYS Office of Parks, Recreation and Historic Preservation to be eligible for listing on the	e		П
	te Register of Historic Places?			
			П	
arc	b. Is the project site, or any portion of it, located in or adjacent to an area designated as sensitive for haeological sites on the NY State Historic Preservation Office (SHPO) archaeological site inventory?			
13.	a. Does any portion of the site of the proposed action, or lands adjoining the proposed action, contain wetlands or other waterbodies regulated by a federal, state or local agency?		NO V	YES
	b. Would the proposed action physically alter, or encroach into, any existing wetland or waterbody?		V	
If Y	Yes, identify the wetland or waterbody and extent of alterations in square feet or acres:			
_				

14. Identify the typical habitat types that occur on, or are likely to be found on the project site. Check all that apply:		
☐ Shoreline ☐ Forest ☑ Agricultural/grasslands ☐ Early mid-successional		
☐ Wetland ☐ Urban ☑ Suburban		
15. Does the site of the proposed action contain any species of animal, or associated habitats, listed by the State or	NO	YES
Federal government as threatened or endangered?		
16. Is the project site located in the 100-year flood plan?	NO	YES
	V	
17. Will the proposed action create storm water discharge, either from point or non-point sources?	NO	YES
If Yes,		V
a. Will storm water discharges flow to adjacent properties?		V
b. Will storm water discharges be directed to established conveyance systems (runoff and storm drains)? If Yes, briefly describe:	V	
in res, offerty describe.		-
	270	X TE C
18. Does the proposed action include construction or other activities that would result in the impoundment of water or other liquids (e.g., retention pond, waste lagoon, dam)?	NO	YES
If Yes, explain the purpose and size of the impoundment:		
A 55,000 gallon stormwater pond is proposed to treat runoff from the proposed construction.		
19. Has the site of the proposed action or an adjoining property been the location of an active or closed solid waste	NO	YES
management facility?	NO	ILS
If Yes, describe:		П
	اكا	
20.Has the site of the proposed action or an adjoining property been the subject of remediation (ongoing or	NO	YES
completed) for hazardous waste? If Yes, describe:		
11 165, describe.		
I CERTIFY THAT THE INFORMATION PROVIDED ABOVE IS TRUE AND ACCURATE TO THE BE MY KNOWLEDGE	ST OF	
1.10.	22	
Applicant/sponsor/name: Jeffrey Jok, N/S Route 5 Self Storage LLC Date:		
Signature:		

EAF Mapper Summary Report

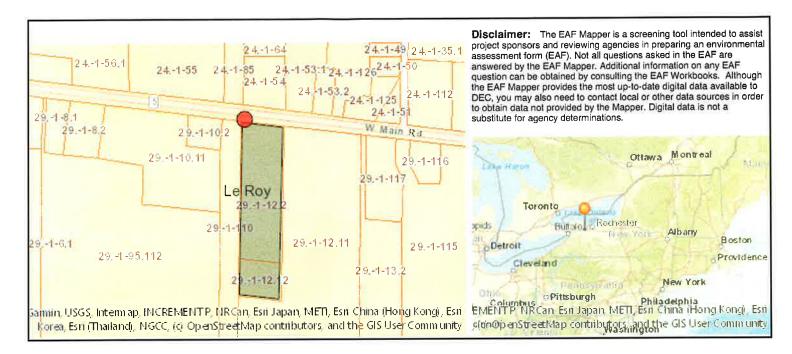

Part 1 / Question 7 [Critical Environmental Area]	No
Part 1 / Question 12a [National or State Register of Historic Places or State Eligible Sites]	No
Part 1 / Question 12b [Archeological Sites]	Yes
Part 1 / Question 13a [Wetlands or Other Regulated Waterbodies]	No
Part 1 / Question 15 [Threatened or Endangered Animal]	No
Part 1 / Question 16 [100 Year Flood Plain]	Digital mapping data are not available or are incomplete. Refer to EAF Workbook.
Part 1 / Question 20 [Remediation Site]	No

ROUTE 5 STORAGE EXPANSION

7054 WEST MAIN ROAD TOWN OF LEROY GENESEE CO., NY

JANUARY 2022

LEGEND

LEGEND	
Existing Proposed	
<u>====</u>	Property Line/R.O.W.
	Centerline
	- Ground Contour
ø U.P.	Utility Pole
OHW	Overhead Wire
UGE	- Underground Electric
——————————————————————————————————————	Gas Main
- — ST — —	Storm Sewer/Culvert
•	Bollard
∕∴Hyd.	Hydrant
———W——	Water Main

PROJECT INFORMATION

Max. Building Height: Max. Coverage:

General Information Owner/Developer: NYS Route 5 Self Storage LLC 7054 W. Main Rd. Property Address: 29.00-1-12.2 29.00-1-12.12 Property T.A.N.: 6.998 acres to R.O.W. (combined area) Property Size: Zoning Information District: C-2 General Commercial District (North portion of 7054 W. Main Rd.) I—1 Industrial District (remainder) Permitted Use: Self Storage (permitted use in C-2 District, special permit use in I-1 District) Required (C-2 District) Required (I-1 District) Proposed no change Min. Lot Width: Min. Front Setback: 324.50 12' (30' min. total) Min. Side Setback:

40' (Allowed)

40% (Allowed)


no change

MAP AND SURVEY NOTES

1. These plans were prepared using a topographic survey map prepared by Welch & O'Donoghue Land Surveyors, P.C. provided for our use on November 24, 2021. Horizontal datum is NAD83. Vertical datum is NAVD88.

GENERAL NOTES

- 1. The plans show subsurface structures, above ground structures and/or utilities from field location and record mapping, exact location of which may vary from the locations indicated. In particular, the Contractor is warned that the exact or even approximate location of such pipelines, subsurface structures and/or utilities in the area may be different from that shown or may not be shown and it is his responsibility to proceed with great care in executing any work. Call Dig Safely New York, telephone number 811, 48 hours before you dig, drill or blast.
- 2. This property is not located within a 100—year flood plain (Zone C per FEMA Flood Insurance Rate Map Community—Panel No. 360280 0003 B, effective date September 14, 1979).
- 3. This property does not contain federal or state wetland areas or the buffer to wetland areas.
- 4. The Contractor shall locate, mark, safeguard, and preserve all survey control monuments in the areas
- 5. This property is located within the Leroy Central School District.
- 6. The property lines and right—of—way lines shown on the plans are for information only, and no warranty
- 7. The Contractor shall maintain in service all existing sewers, culverts, ditches, manholes, and catch
- 8. Construction Stakeout: The Contractor is responsible for all construction stakeout as shown on the plans.
- 9. Traffic shall be maintained throughout construction. Ingress and egress to driveways, parking lots, and service roads shall be continuously maintained throughout the period of construction.
- 10. The Contractor shall take care to prevent damage to existing utilities. Damaged utilities shall be immediately repaired by the Contractor at the Contractor's expense.
- 11. All proposed utilities and appurtenances shall be constructed in compliance with the local municipalities' codes and regulations governing the installation of such utilities.
- 12. The Contractor shall be responsible for obtaining and incurring the cost of all required permits, inspections, certificates, etc. and shall comply with all required permits.
- 13. All work shall be done in strict compliance with all applicable National, State, and local codes, standards, ordinances, rules, and regulations.
- 14. Miscellaneous work not specifically shown on the contract drawings such as patching, blocking, trimming, etc. shall be performed as required to make the work complete.
- 15. It is the Contractor's responsibility to examine all plan sheets and coordinate work with all other
- 16. The Engineer shall be notified in writing of any conditions that vary from those shown on the plans. The Contractor's work shall not vary from the plans without the expressed approval of the Engineer.
- 17. The Contractor shall restore lawns, driveways, culverts, signs, and other public or private property damaged or removed to at least as good a condition as before being disturbed as determined by the
- Engineer. Any damaged trees, shrubs, and/or hedges shall be replaced at the Contractor's expense. 18. Unsuitable material shall be removed from the site and properly disposed.
- 19. At the time of completion and acceptance of the work, all areas disturbed by the Contractor's operations shall be finished, graded, topsoiled, and seeded per the specifications.
- 20. All improvements shall be in accordance with the most recent standards and specifications of the Town
- 21. All site lighting shall be in accordance with the most recent standards and specifications of the Town
- 22. Buildings shall comply with the New York State Uniform Fire Prevention and Building Code.
- 23. The Contractor shall designate a member of his or her firm to be responsible to monitor erosion control, erosion control structures, tree protection, and preservation throughout construction.

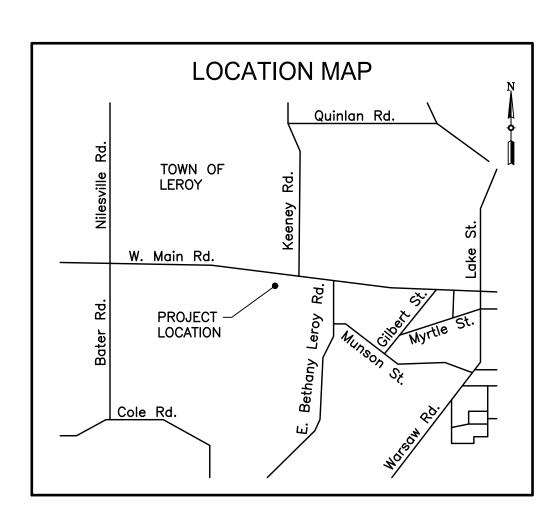


		INDEX OF DRAWINGS
SHEET NUMBER	DRAWING NUMBER	TITLE
1		COVER SHEET
2	S-1	SITE/UTILITY PLAN
3	S-2	GRADING, DRAINAGE, AND SOIL EROSION/SEDIMENT CONTROL PLAN
4	S-3	LIGHTING PLAN
5	D-1	MISCELLANEOUS DETAILS
6	D-2	STORMWATER MANAGEMENT DETAILS



Planning Board Chairperson

Town Engineer

Date

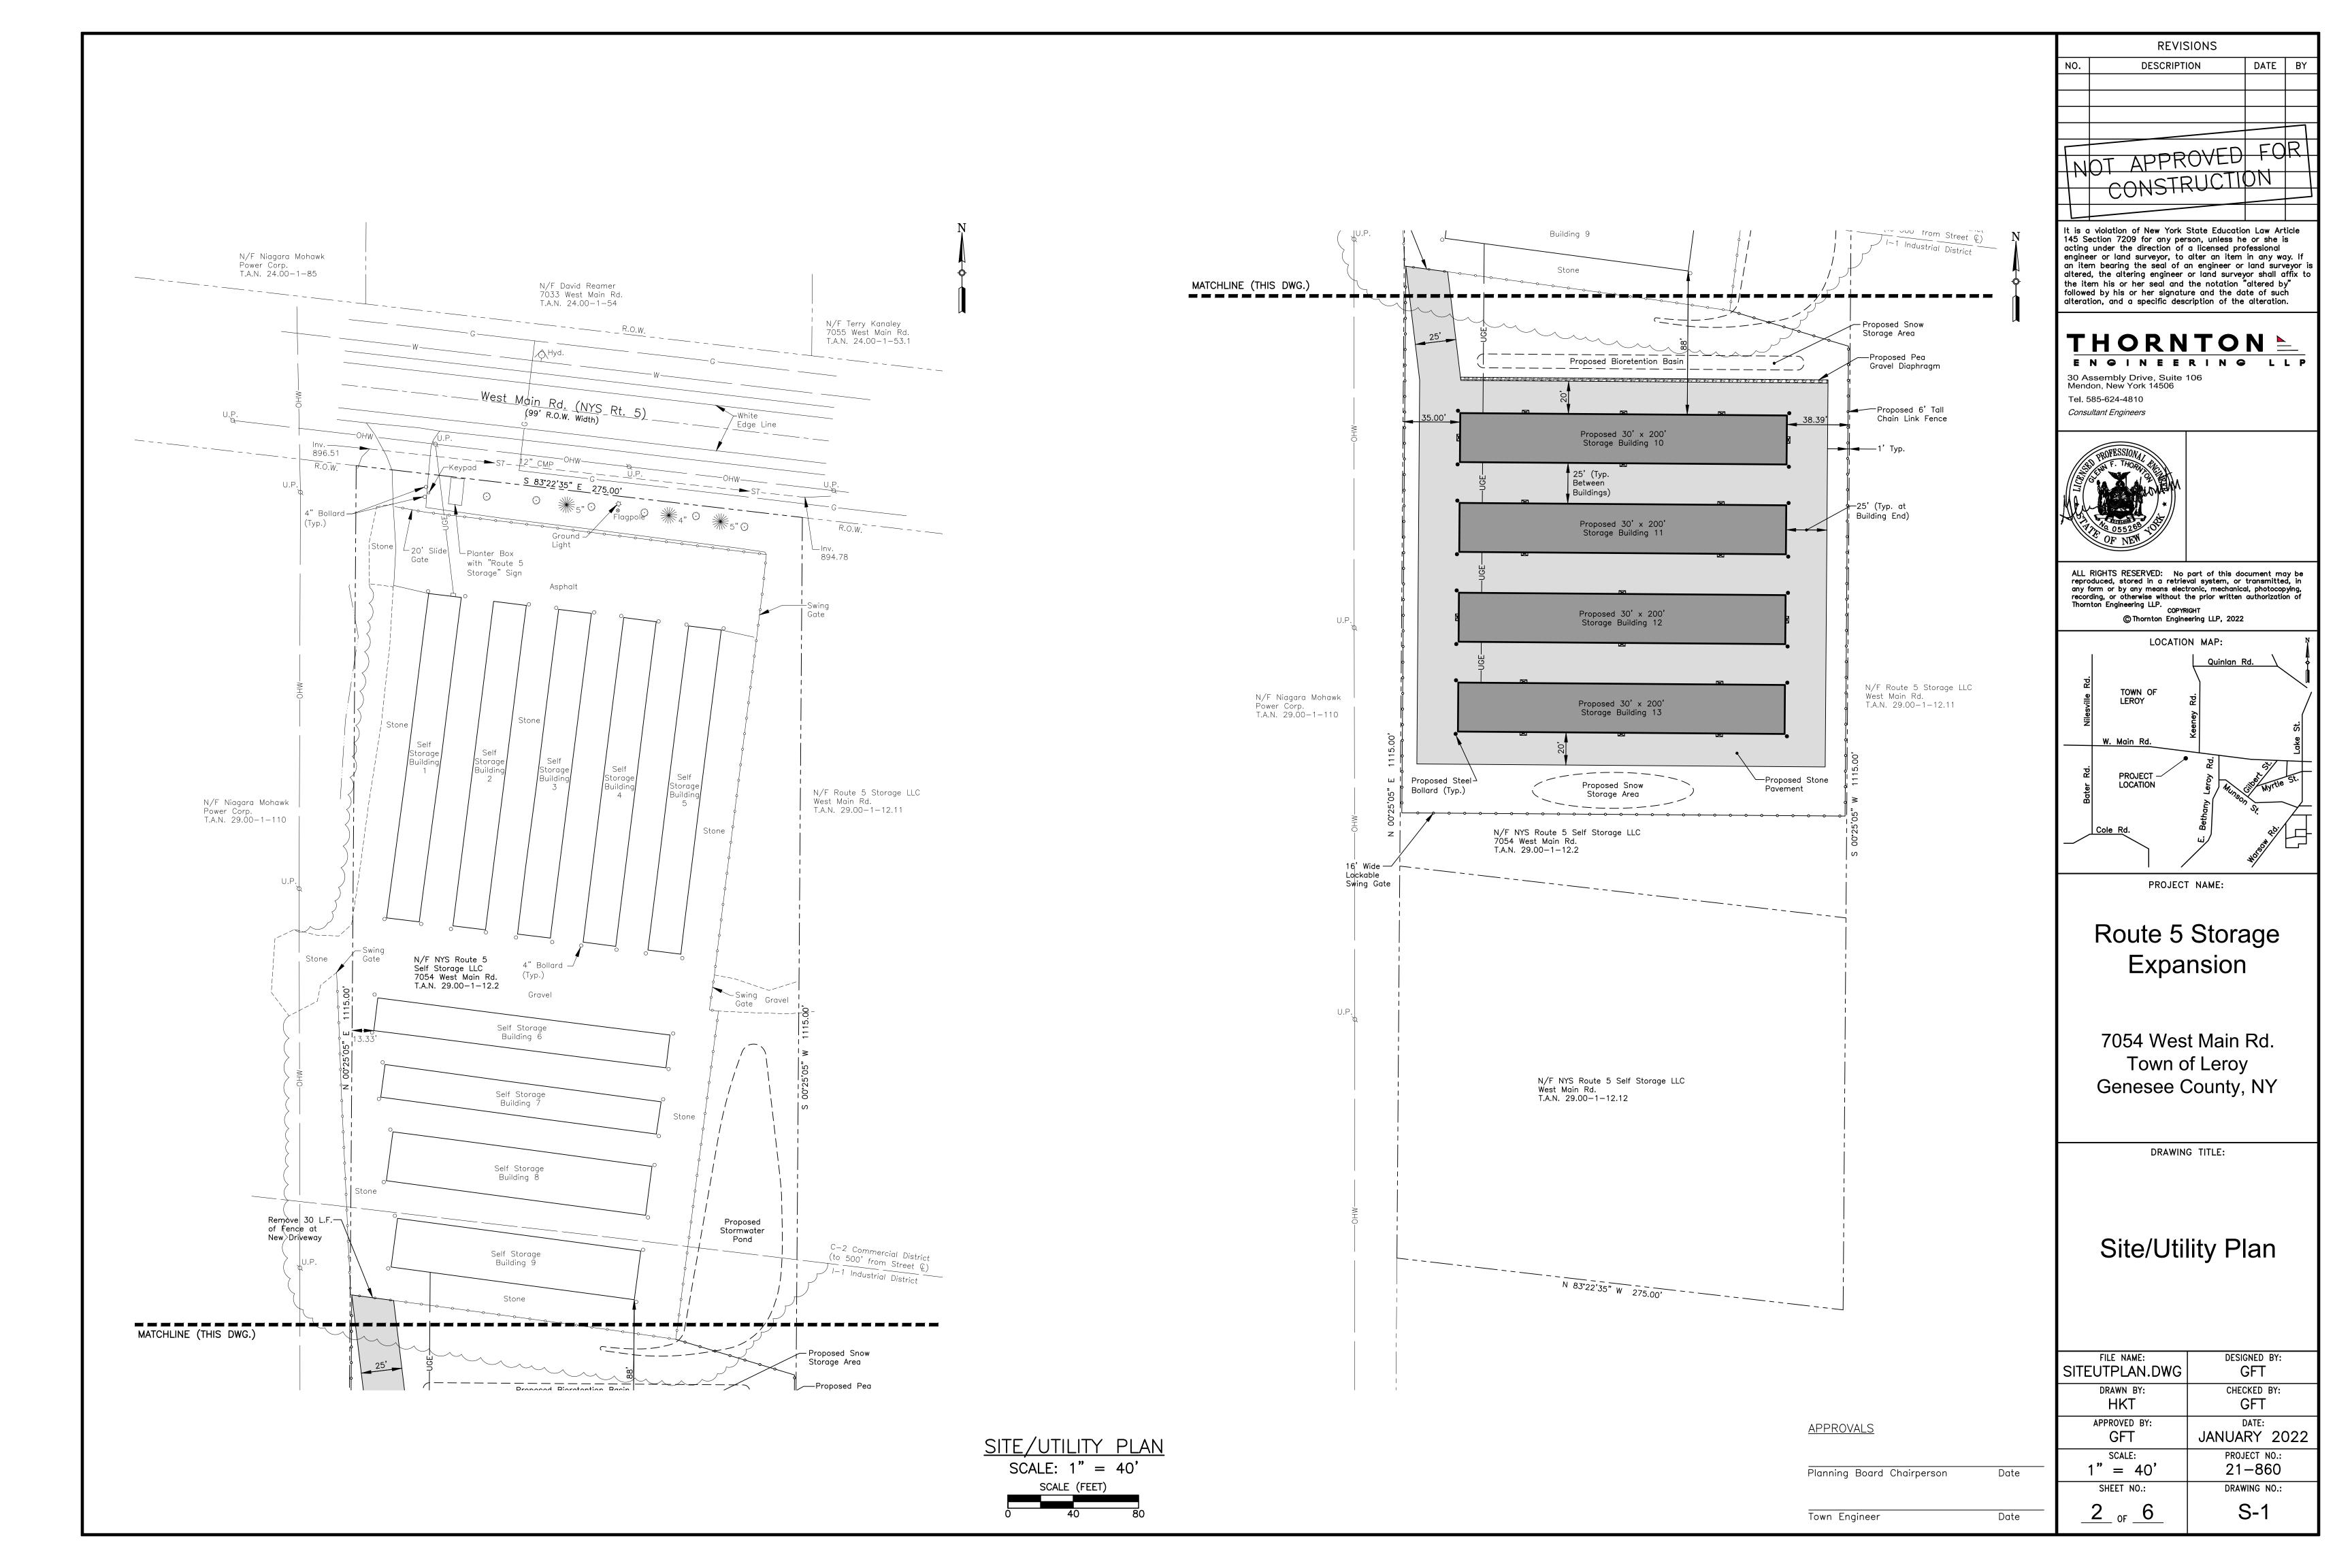

SOIL EROSION/SEDIMENTATION CONTROL NOTES

- 1. Developer shall install erosion and siltation control measures during construction to prevent off—site transport and deposition of materials. All erosion and siltation control measures shall be in place and approved by the Town or their duly noted representative prior to any construction activities, including clearing.
- 2. The temporary erosion/sedimentation control measures depicted on the site plan shall be supplemented with additional controls if found necessary during construction. Developer is responsible for establishing the controls during construction, and removing the controls following re—establishment of ground cover.
- 3. All sedimentation control structures shall remain in effective operating condition.
- 4. No erosion or sediment control measures may be removed until the upland areas are stabilized and/or approval of their removal has been granted by the Town.
- 5. All access to and from the site shall be via the stabilized construction entrances, which shall be kept clean and free of debris and sediment. Any debris or sediment which makes its way to the public highway shall be immediately removed.
- 6. Any erosion or sediment control measure shall be immediately cleaned, repaired, and/or replaced upon notice of any damage.
- 7. In areas where soil disturbance activity has been temporarily or permanently ceased, temporary and/or permanent soil stabilization measures shall be installed and/or implemented within seven (7) days from the date the soil disturbance activity ceased. The soil stabilization measures selected shall be in conformance with the most current version of the technical standard, New York State Standards and Specifications for Erosion and Sediment Control.
- 8. All erosion and sediment control methods are to be designed and installed in accordance with the latest edition of the New York State Standards and Specifications for Erosion and Sediment Control.
- 9. Pollution prevention practices shall be employed during construction to prevent litter, construction chemicals and construction debris from becoming a pollutant source in stormwater. The following controls shall be implemented:
- Litter and construction debris shall be picked up on a daily basis and placed within covered trash receptacles. - Construction materials that are temporarily stored in the work area shall be secured with straps or anchors, or covered to
- prevent wind transport. - All points of entry into the storm drainage system shall be screened to prevent entry of litter or debris. • Construction chemicals and hazardous substances shall be stored in accordance with all applicable environmental regulations. The Contractor shall have appropriate spill containment devices on the jobsite at all times.
- 10. The Contractor shall inspect temporary silt fences and temporary stabilized construction entrances following each 0.5 inch rain
- event and at not more than seven day intervals.

11. Seed Mixes:

Temporary (50 lbs. per acre) 50% by Weight (90% Purity) Annual Ryegrass Tall Fescue 50% by Weight (90% Purity)

<u>Permanent</u> Kentucky Bluegrass 45% by Weight (85% Purity) Red Fescue (Commercial)

Common Ryegrass

40% by Weight (95% Purity) 15% by Weight (95% Purity)

CONSTRUCTION SEQUENCE

- Step 1 Install stabilized construction entrance.
- Step 2 Install silt fence at the locations indicated on the plan.
- Step 3 Clear vegetation within the work limits.
- Step 4 Strip topsoil and place it within the designated storage areas or remove it from
- Step 5 Mass grade the development area including the stormwater pond.
- Step 6 Construct diversion swales as required to direct storm runoff into the pond which will serve as a temporary sediment basin during construction.
- Step 7 Construct the outlet control structure and encircle with silt fence to prevent offsite
- Step 8 Prepare the building pads and immediately place crushed stone subbase material
- Step 9 Fine grade pavement areas and immediately place crushed stone base and surface
- Step 10 Construct the bioretention basin.
- Step 11 Fine grade, topsoil, seed, and mulch all areas that will not require future
- Step 12 Following establishment of a healthy growth of turf within all disturbed areas, remove the silt fence.

Pavement Elev.at Building = 908.30 -Pavement Elev. Finished — –High Point at Building = Pavement | Elev. 907.40 907.45 Surface 907.50

Proposed Area of Ground

Disturbance = 2.17 Acres

SECTION A-A PAVEMENT CROSS SECTION BETWEEN BUILDINGS 10 AND 11 AT HIGH POINT IN SWALE (SECTION BETWEEN BUILDINGS 11 AND 12 AND 12 AND 13 IS SIMILAR) NOT TO SCALE

ADDITIONAL NYSDEC GP-0-20-001 STORMWATER PERMIT REQ'S.


1. Bioretention basins shall be planted per the details.

2. All disturbed areas must be restored in accordance with the Soil Restoration Requirements in Table 5.3 of the NYS Stormwater Management Design Manual. In general, areas without a change in grade should be aerated and 6" of topsoil should be applied. Aeration includes the use of machines such as tractor drawn implements with coulters making a narrow slit in the soil, a roller with many spikes making indentation in the soil, or prongs which function like a

Areas of cut of fill shall receive full restoration in accordance with "Deep—Ripping and Decompaction, April 2008" issued by the NYSDEC. Deep—ripping requires the use of heavy duty agricultural grade implements and machinery to thoroughly decompact (till) the subsoil to a depth of 20" to 24" during the first phase, followed by thoroughly tilling the replaced topsoil and upper 12" of decompacted subsoil during the second phase.

PROPOSED STORMWATER MANAGEMENT AREA


		Water Surface	Discharge
Sizing Criteria	Storage Provided	<u>Elevation</u>	<u>Rate</u>
Water Quality	0.02 acre feet	899.00	
Channel Protection	0.09 acre feet	900.07	0.04 cfs
Overbank Flood Control	0.10 acre feet	900.19	3.69 cfs
Extreme Flood Control	0.17 acre feet	900.90	9.19 cfs

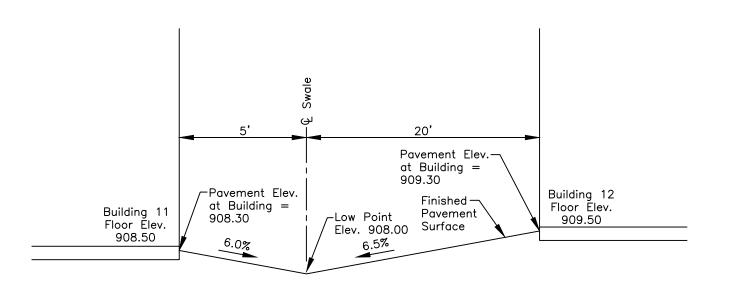


SECTION B-B PAVEMENT CROSS SECTION BETWEEN ENDS OF BUILDINGS 11 AND 12 (SECTION BETWEEN ENDS OF BUILDINGS 10 AND 11 AND 12 AND 13 IS SIMILAR) NOT TO SCALE

<u>APPROVALS</u>

Planning Board Chairperson Date Town Engineer Date

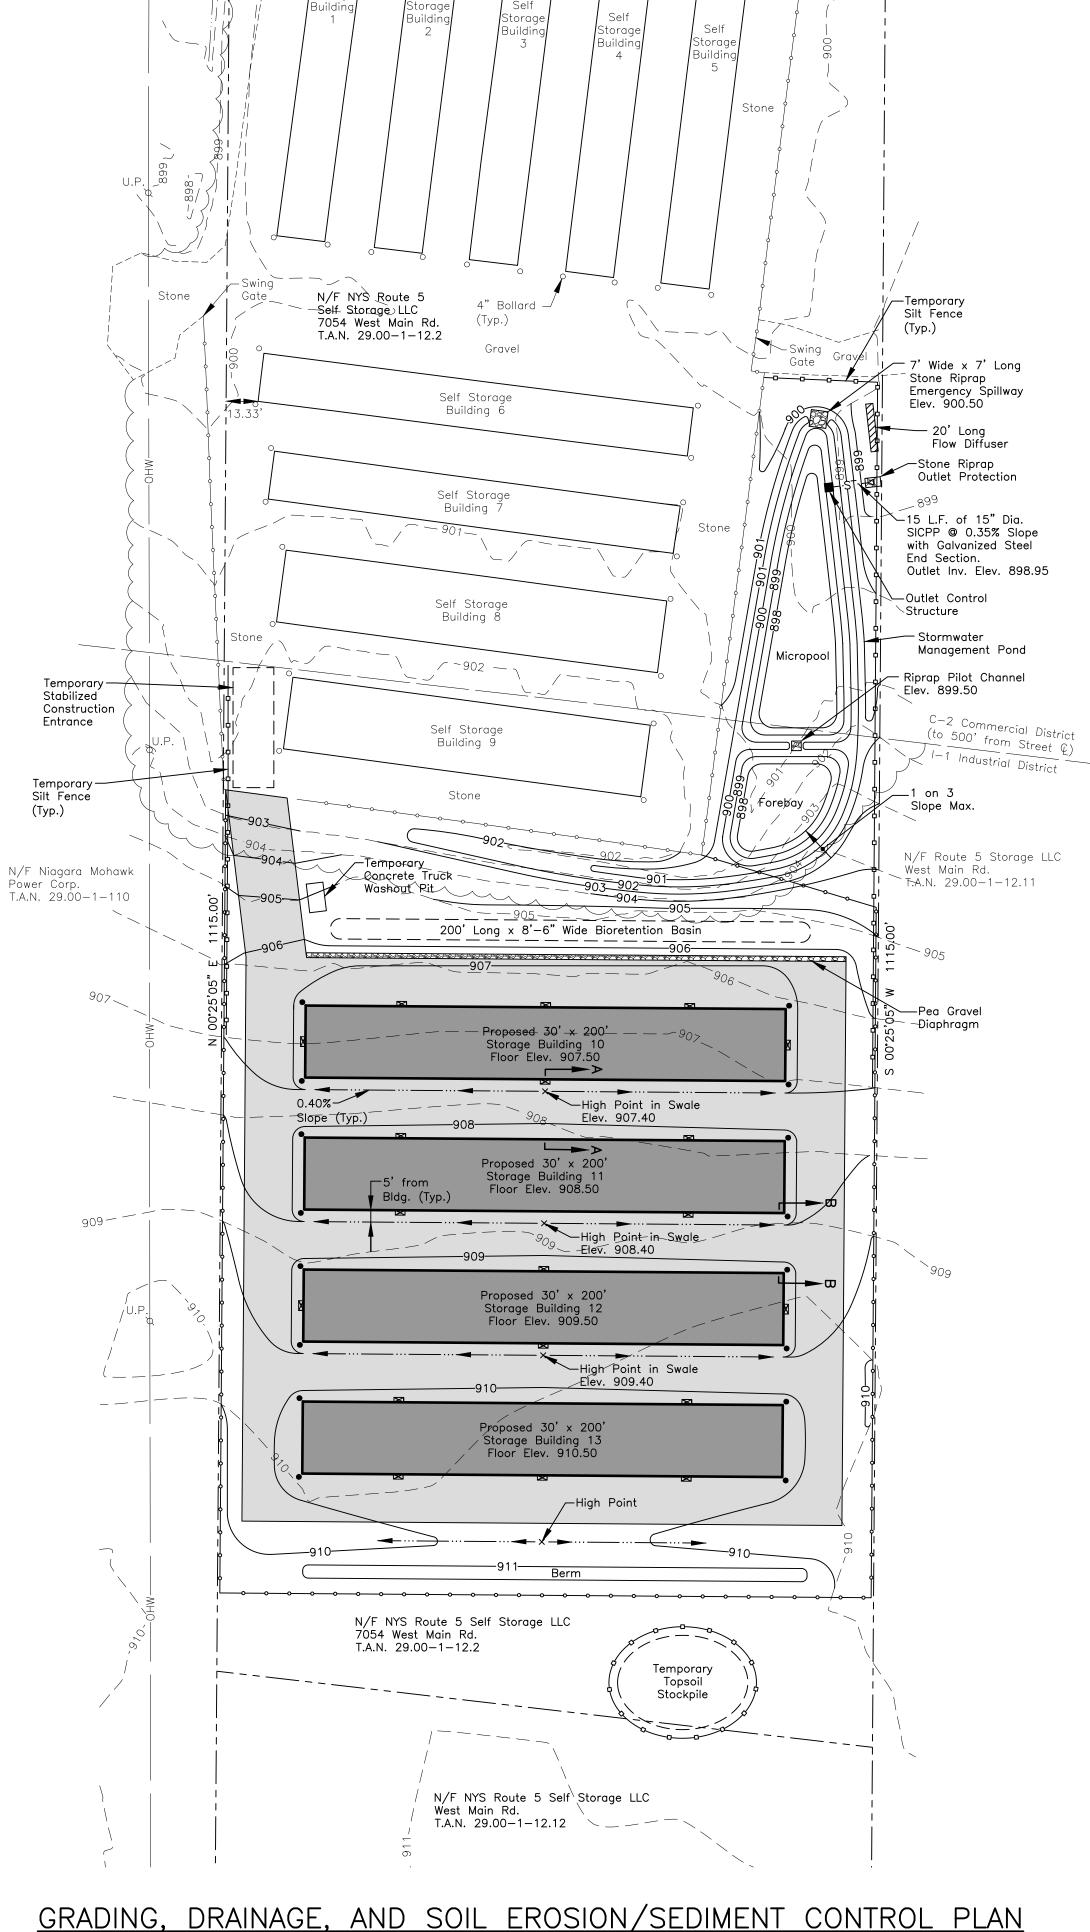

SCALE: 1" = 40'

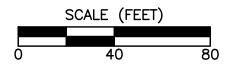

	REVISIONS		
NO.	DESCRIPTION	DATE	BY
			_
TN	OT APPROVED	FO	R_{\perp}
114	CONSTRUCTION	NC	

t is a violation of New York State Education Law Article 145 Section 7209 for any person, unless he or she is acting under the direction of a licensed professional engineer or land surveyor, to alter an item in any way. I an item bearing the seal of an engineer or land surveyor altered, the altering engineer or land surveyor shall affix t the item his or her seal and the notation "altered by" followed by his or her signature and the date of such alteration, and a specific description of the alteration.


THORNTON **\(\)**

30 Assembly Drive, Suite 106 Mendon, New York 14506 Tel. 585-624-4810 Consultant Engineers



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PROJECT NAME:

Route 5 Storage Expansion

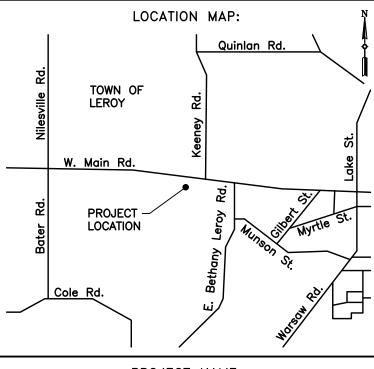7054 West Main Rd. Town of Leroy Genesee County, NY

DRAWING TITLE:

Grading, Drainage, and Soil **Erosion/Sediment** Control Plan

FILE NAME: GRADINGPLAN.DWG	DESIGNED BY: GFT
drawn by: HKT	CHECKED BY: GFT
APPROVED BY: GFT	DATE: JANUARY 2022
SCALE: 1" = 40'	PROJECT NO.: 21-860
SHEET NO.:	DRAWING NO.:
3 of _6_	S-2



11.5"

Depth (D1):

Depth (D2):

Height: Width:

WDGE2 LED Architectural Wall Sconce

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Catalog WDGE2 LED P3 4000K

Hit the Tab key or mouse over the page to see all interactive elements. Introduction

The WDGE LED family is designed to meet specifier's every wall-mounted lighting need in a widely accepted shape that blends with any architecture. The clean rectilinear design comes in four sizes with lumen packages ranging from 1,200 to 25,000 lumens, providing a true site-wide solution. Embedded with nLight® AIR wireless controls, the WDGE family provides additional energy savings and code compliance. WDGE2 delivers up to 6,000 lumens with a soft, non-pixelated light source, creating a visually comfortable environment. When combined with multiple integrated emergency battery backup options, including an 18W cold temperature mounted lighting solution for pedestrian scale applications in any environment.

WDGE LED Family Overview WDGE1 LED 4W -- -- 1,200 2,000 -- -- --
 WDGE2 LED
 10W
 18W
 Standalone / nLight
 1,200
 2,000
 3,000
 4,500
 6,000
 -

 WDGE3 LED
 15W
 18W
 Standalone / nLight
 7,500
 8,500
 10,000
 12,000
 - - -

 WDGE4 LED
 - - Standalone / nLight
 12,000
 16,000
 18,000
 20,000
 22,000
 25,000
 EXAMPLE: WDGE2 LED P3 40K 80CRI VF MVOLT SRM DDBXD

E4WH Emergency battery backup, Certified in CA Title 20 MAEDBS Standalone Sensors/Controls (only available with P15W, P25W & P35W)

(4W, 0°C min)

PIR Ri Javad (100/3506) motion concer for 8.15° mounting half PIR Bi-level (100/35%) motion sensor for 8-15' mounting heights. Intended for use on switched circuits with external dusk to dawn switching. E10WH Emergency battery backup, Certified in CA Title 20 MAEDBS (10W, 5°C min) PIRH Bi-level (100/35%) motion sensor for 15-30' mounting heights. Intended for use on E20WC Emergency battery backup, Certified in CA Title 20 MAEDBS (18W, -20°C min) PIR1FC3V Bi-level (100/35%) motion sensor for 8-15' mounting heights with photocell pre-PE⁴ Photocell, Button Type programmed for dusk to dawn operation.

DNAXD Natural aluminum DDBTXD Textured dark bronze DBLBXD Textured black

LIGHTING NOTE

1. New exterior lighting shall not exceed

0.5 footcandles at the property line or beyond the property line.

DWHGXD Textured white

NLTAIR2 PIR nLightAIR Wireless enabled bi-level motion/ambient sensor for 8-15' mounting heights. DSSTXD Textured sandstone

LITHONIA
LIGHTING.

COMMERCIAL OUTDOOR

One Lithonia Way • Conyers, Georgia 30012 • Phone: 1-800-705-SERV (7378) • www.lithonia.com
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BCE Bottom conduit entry for back box (PBBW). Total of 4 entry NLTAIR2 PIRH nLIGHT PIRH nL

DS 5 Dual switching (comes with 2 drivers and 2 light engines; see page 3 for details) PIRH1FC3V BI-level (100/35%) motion sensor for 15–30' mounting heights with photocell preprogrammed for dusk to dawn operation. DMG⁶ 0-10V dimming wires pulled outside fixture (for use with an external control, ordered separately)

Networked Sensors/Controls (only available with PTSW, PZSW & P3SW)

NITAIR2 PIR nLightAll Wireless enabled bi-level motion/ambient senso

Route 5 Storage Expansion

PROJECT NAME:

REVISIONS

It is a violation of New York State Education Law Article 145 Section 7209 for any person, unless he or she is

an item bearing the seal of an engineer or land surveyor i altered, the altering engineer or land surveyor shall affix to

acting under the direction of a licensed professional engineer or land surveyor, to alter an item in any way. I

the item his or her seal and the notation "altered by" followed by his or her signature and the date of such

alteration, and a specific description of the alteration.

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TOWN OF LEROY

W. Main Rd.

LOCATION

LOCATION MAP:

Quinlan Rd.

30 Assembly Drive, Suite 106 Mendon, New York 14506

Tel. 585-624-4810 Consultant Engineers DATE BY

7054 West Main Rd. Town of Leroy Genesee County, NY

DRAWING TITLE:

Lighting Plan

IGHTINGPLAN.DWG	GFT
drawn by: HKT	CHECKED BY: GFT
APPROVED BY: GFT	DATE: JANUARY 2022
scale: 1" = 40'	PROJECT NO.: 21-860
SHEET NO.:	DRAWING NO.:
_4 _{of} _6_	S-3

LIGHTING PLAN SCALE: 1" = 40

N/F NYS Route 5 Self Storage LLC West Main Rd. T.A.N. 29.00-1-12.12

Gate

Stone

N/F Niagara Mohawk

Power Corp. T.A.N. 29.00-1-110

N/F NYS Route 5

Self Storage LLC 7054 West Main Rd.

T.A.N. 29.00-1-12.2

Building 6

Building 7

Building 8

Building 9

(5.0) (5.0) (5.0) (5.0) (5.0) (5.0) (5.0) (5.0)

Proposed 30' x 200' Storage Building 13

N/F NYS Route 5 Self Storage LLC 7054 West Main Rd. T.A.N. 29.00-1-12.2

Luminaire (Typ.)

Lighting Contour—(Isofootcandle) (Typ.)

Swing Gravel


(to 500' from Street ()

N/F Route 5 Storage LLC

West Main Rd. T.A.N. 29.00-1-12.11

Planning Board Chairperson Date Town Engineer Date

<u>APPROVALS</u>

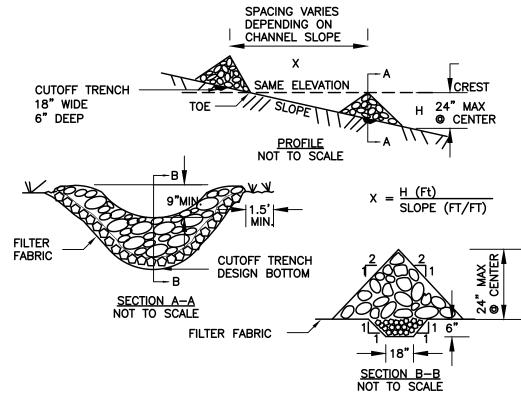


CONSTRUCTION SPECIFICATIONS

- 1. STONE WILL BE PLACED ON A FILTER FABRIC FOUNDATION TO THE LINES, GRADES AND LOCATIONS SHOWN IN THE PLAN.
- 2. SET SPACING OF CHECK DAMS TO ASSUME THAT THE ELEVATIONS OF THE CREST OF THE DOWNSTREAM DAM IS AT THE SAME ELEVATION OF THE TOE OF THE
- 3. EXTEND THE STONE A MINIMUM OF 1.5 FEET BEYOND THE DITCH BANKS TO PREVENT CUTTING AROUND THE DAM.
- 4. PROTECT THE CHANNEL DOWNSTREAM OF THE LOWEST CHECK DAM FROM SCOUR AND EROSION WITH STONE OR LINER AS APPROPRIATE.
- 5. ENSURE THAT CHANNEL APPURTENANCES SUCH AS CULVERT ENTRANCES BELOW CHECK DAMS ARE NOT SUBJECT TO DAMAGE OR BLOCKAGE FROM DISPLACED STONE. MAXIMUM DRAINAGE AREA 2 ACRES.

TEMPORARY ROCK CHECK DAM

NOT TO SCALE

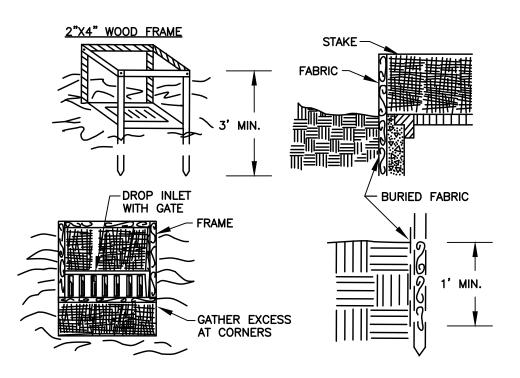


<u>NOTES</u>


- 1. FILTER FABRIC SHALL HAVE AN EOS OF 40-85. BURLAP MAY BE USED FOR SHORT TERM APPLICATIONS.
- 2. CUT FABRIC FROM A CONTINUOUS ROLL TO ELIMINATE JOINTS. IF JOINTS ARE NEEDED THEY WILL BE OVERLAPPED TO THE NEXT STAKE.
- 3. STAKE MATERIALS WILL BE STANDARD 2" x 4" WOOD OR EQUIVALENT. METAL WITH A MINIMUM LENGTH OF 3 FEET.
- 4. SPACE STAKES EVENLY AROUND INLET 3 FEET APART AND DRIVE A MINIMUM 18 INCHES DEEP. SPANS GREATER THAN 3 FEET MAY BE BRIDGE!
- WITH THE USE OF WIRE MESH BEHIND THE FILTER FABRIC FOR SUPPORT.
- 5. FABRIC SHALL BE EMBEDDED 1 FOOT MINIMUM BELOW GROUND AND BACKFILLED. IT SHALL BE SECURELY FASTENED TO THE STAKES AND FRAME.
- 6. A 2" x 4" WOOD FRAME SHALL BE COMPLETED AROUND THE CREST OF THE FABRIC FOR OVER FLOW STABILITY.
- 7. MAXIMUM DRAINAGE AREA 1 ACRE.

TEMPORARY FILTER FABRIC

DROP INLET PROTECTION


NOT TO SCALE

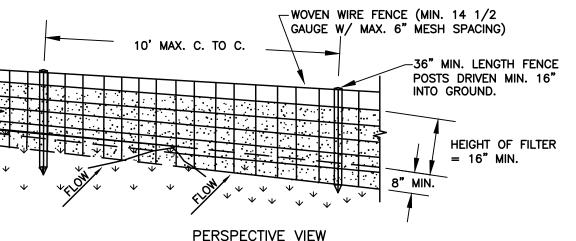

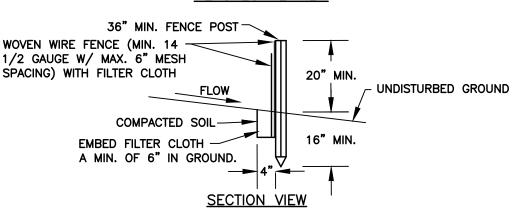

- CONSTRUCTION SPECIFICATIONS
- 1. WOVEN WIRE FENCE TO BE FASTENED SECURELY TO FENCE POSTS WITH WIRE TIES OR STAPLES. POSTS SHALL BE STEEL EITHER "T" OR "U" TYPE OR HARDWOOD.
- 2. FILTER CLOTH TO BE TO BE FASTENED SECURELY TO WOVEN WIRE FENCE WITH TIES SPACED EVERY 24" AT TOP AND MID SECTION. FENCE SHALL BE WOVEN WIRE, 12 1/2 GAUGE, 6" MAXIMUM MESH OPENING.
- 3. WHEN TWO SECTIONS OF FILTER CLOTH ADJOIN EACH OTHER THEY SHALL BE OVER-LAPPED BY 6" AND FOLDED. FILTER CLOTH SHALL BE EITHER FILTER X, MIRAFI 100X, STABILINKA T140N, OR APPROVED EQUIVALENT.
- 4. PREFABRICATED UNITS SHALL BE GEOFAB, ENVIROFENCE, OR APPROVED EQUIVALENT.
- 5. MAINTENANCE SHALL BE PERFORMED AS NEEDED AND MATERIAL REMOVED WHEN "BULGES" DEVELOP IN THE SILT FENCE.

TEMPORARY SILT FENCE
NOT TO SCALE

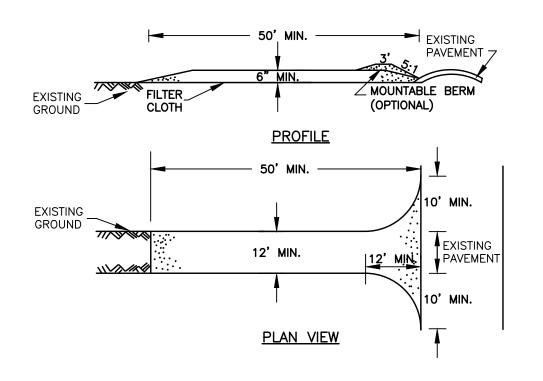


CONSTRUCTION SPECIFICATIONS

- 1. STONE SIZE USE 2" STONE, OR RECLAIMED OR RECYCLED CONCRETE EQUIVALENT.
- 2. LENGTH NOT LESS THAN 50' (EXCEPT ON A SINGLE RESIDENCE LOT WHERE A 30' MINIMUM LENGTH WOULD APPLY).
- 3. THICKNESS NOT LESS THAN 6".
- 4. WIDTH 12' MINIMUM, BUT NOT LESS THAN THE FULL WIDTH AT POINTS WHERE INGRESS OR EGRESS OCCURS. 24' IF SINGLE ENTRANCE TO SITE.
- 5. FILTER CLOTH WILL BE PLACED OVER THE ENTIRE AREA PRIOR TO PLACING OF STONE.
- SURFACE WATER ALL SURFACE WATER FLOWING OR DIVERTED TOWARD CONSTRUCTION ENTRANCES SHALL BE PIPED ACROSS THE ENTRANCE. IF PIPING IS IMPRACTICAL, A MOUNTABLE BERM WITH 5:1 SLOPES WILL BE PERMITTED.
- 7. MAINTENANCE THE ENTRANCE SHALL BE MAINTAINED IN A CONDITION WHICH WILL PREVENT TRACKING OR FLOWING OF SEDIMENT ONTO PUBLIC RIGHTS—OF—WAY, ALL SEDIMENT SPILLED, DROPPED, WASHED OR TRACTED ONTO PUBLIC RIGHTS—OF—WAY MUST BE REMOVED IMMEDIATELY.
- 8. WHEN WASHING IS REQUIRED, IT SHALL BE DONE ON AN AREA STABILIZED WITH
- STONE AND WHICH DRAINS INTO AN APPROVED SEDIMENT TRAPPING DEVICE.


 9. PERIODIC INSPECTION AND NEEDED MAINTENANCE SHALL BE PROVIDED AFTER EACH

TEMPORARY STABILIZED
CONSTRUCTION ENTRANCE
NOT TO SCALE

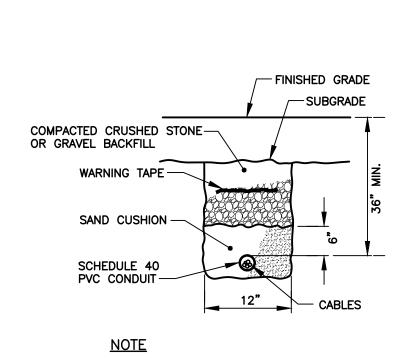


ELECTRICAL CIRCUITS HAVE NOT BEEN DEPICTED ON THE LIGHTING PLAN.

ELECTRIC SERVICE TRENCH
NOT TO SCALE

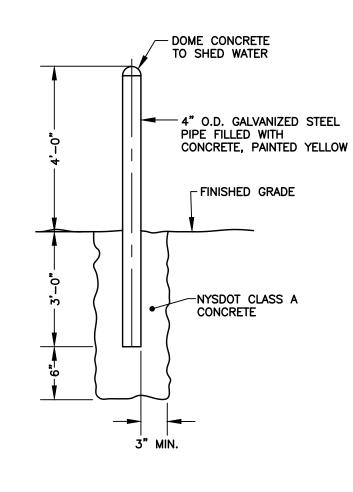


STEEL PIPE BOLLARD
NOT TO SCALE

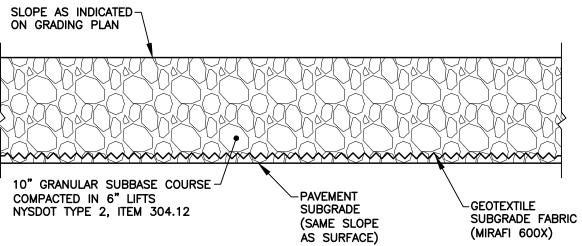

<u>NOTES</u>

- 1. PAVEMENT SUBGRADE AREAS WITHIN EXCAVATION AREAS SHALL BE COMPACTED TO A DEPTH OF SIX INCHES AND TO A DENSITY OF NOT LESS THAN 95% OF THE MAXIMUM DENSITY AS DETERMINED BY ASTM D-1557.
- 2. EMBANKMENTS CONSTRUCTED BENEATH PAVEMENTS SHALL BE PLACED IN ACCORDANCE WITH NYSDOT STANDARD SPECIFICATIONS SECTION 203 EARTHWORK. EMBANKMENTS SHALL BE CONSTRUCTED WITH SUITABLE MATERIAL AS DESCRIBED IN SUBSECTION 203—1.08, COMPACTED TO AT LEAST 90% OF STANDARD PROCTOR MAXIMUM DENSITY. EMBANKMENTS WITHIN 24" OF THE SUBGRADE ELEVATION SHALL NOT CONTAIN MATERIAL EXCEEDING 6" IN DIAMETER AND SHALL BE COMPACTED TO AT LEAST 95% OF STANDARD PROCTOR MAXIMUM DENSITY.
- 3. ALL EXISTING TOPSOIL SHALL BE REMOVED FROM ALL PROPOSED BUILDING AND PAVEMENT AREAS. EXCAVATED AREAS BELOW THE PAVEMENT AND BUILDING SUBGRADE SHALL BE FILLED WITH COMPACTED GRANULAR SUBBASE COURSE OR SUITABLE EMBANKMENT MATERIAL.

STONE PAVEMENT
NOT TO SCALE

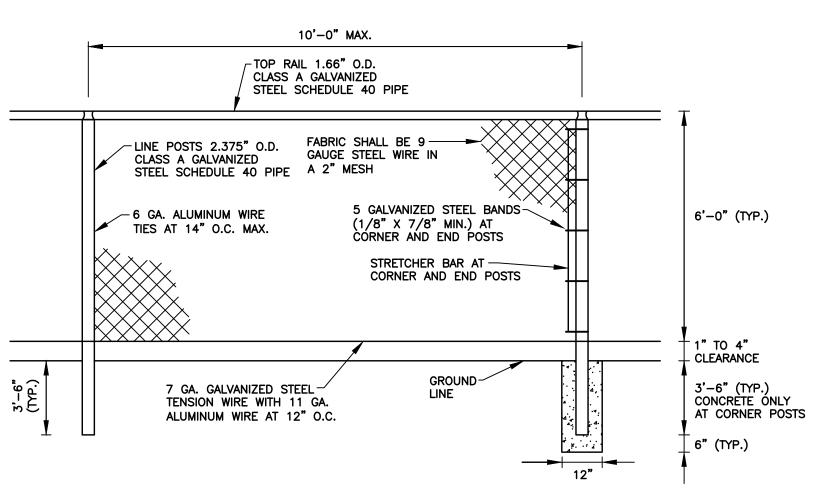

CHAIN LINK FENCE
NOT TO SCALE

NO. DESCRIPTION DATE BY NO. DESCRIPTION DATE BY NOT APPROVED FOR CONSTRUCTION


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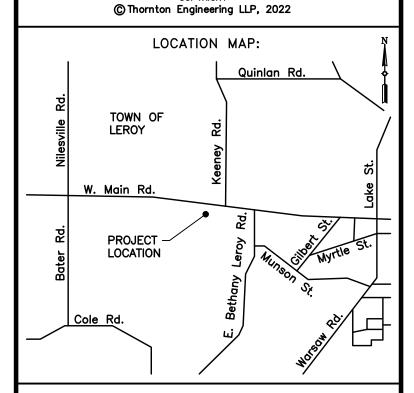
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PROJECT NAME:


Route 5 Storage Expansion

7054 West Main Rd. Town of Leroy Genesee County, NY

DRAWING TITLE:

Miscellaneous Details

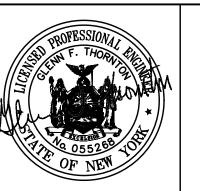FILE NAME: DETAILS.DWG	DESIGNED BY: GFT
drawn by: HKT	CHECKED BY: GFT
APPROVED BY: GFT	DATE: JANUARY 2022
SCALE: NOT TO SCALE	PROJECT NO.: 21-860
SHEET NO.:	DRAWING NO.:
5 of _6_	D-1

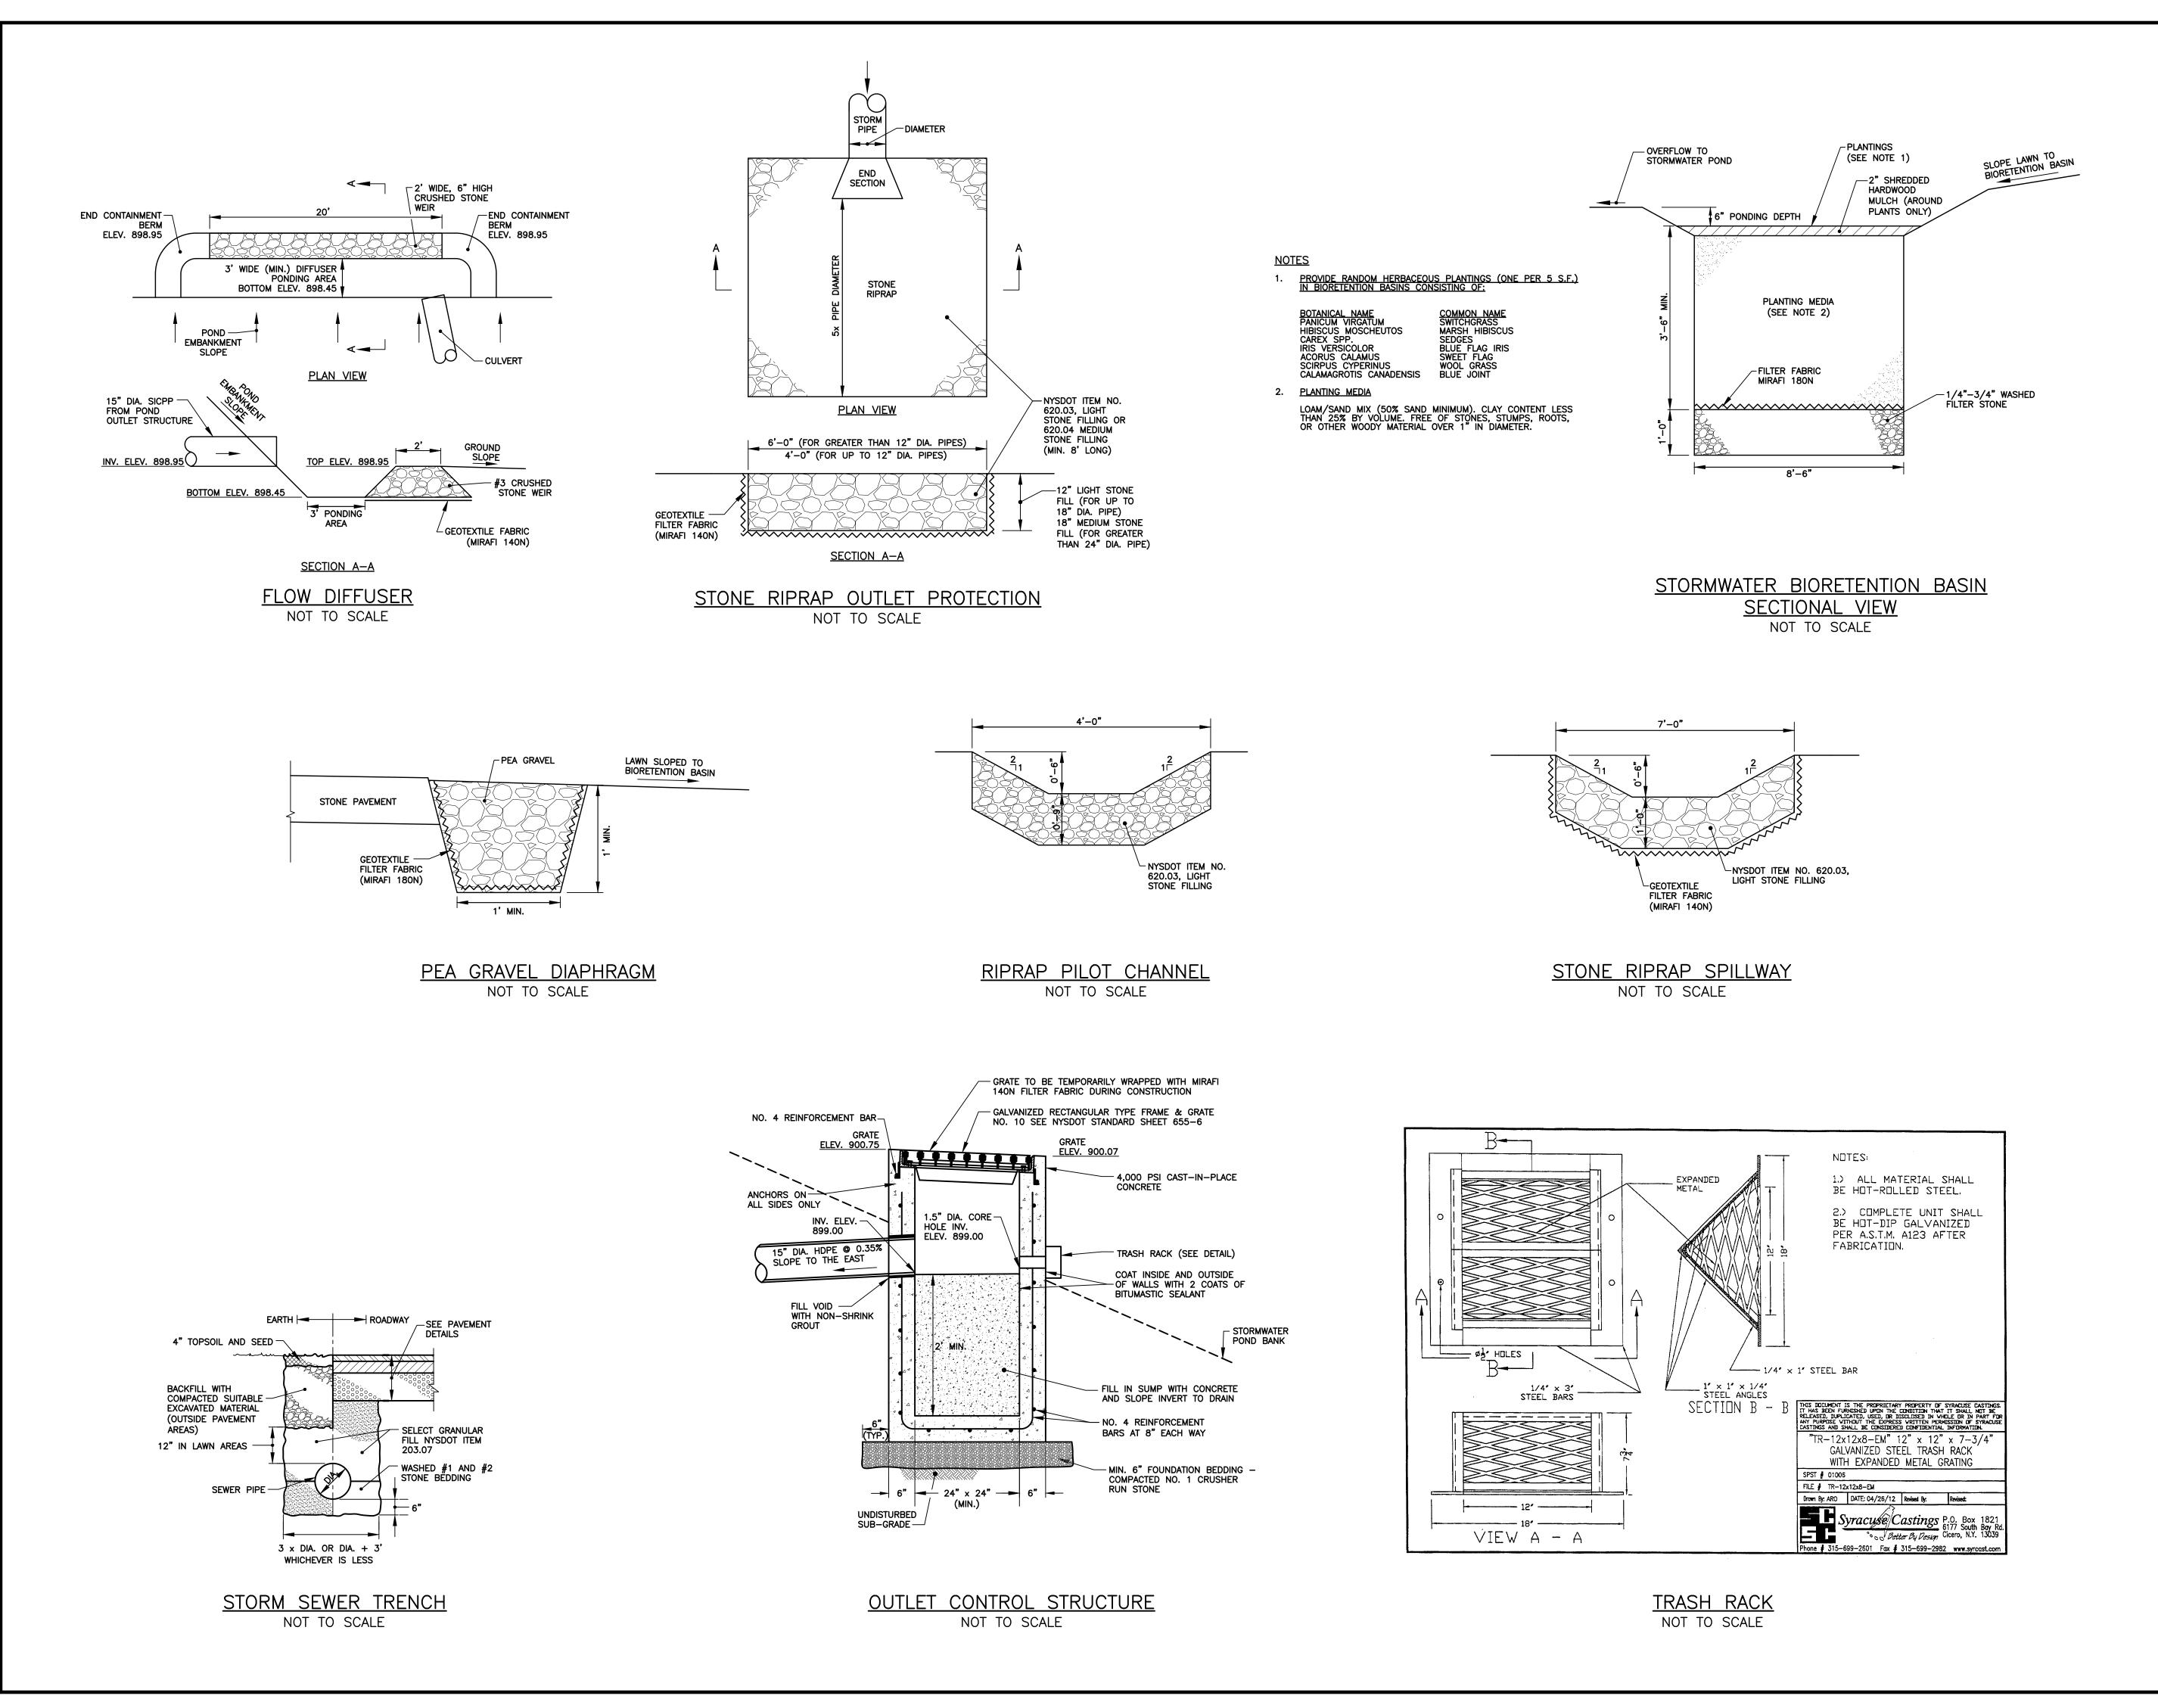

NO. DESCRIPTION DATE BY

NOT APPROVED FOR

CONSTRUCTION


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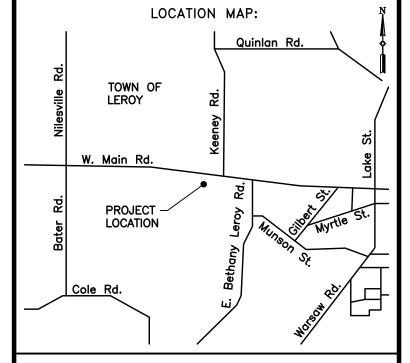
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PROJECT NAME:

Route 5 Storage Expansion

7054 West Main Rd.
Town of Leroy
Genesee County, NY

DRAWING TITLE:

Stormwater Management Details

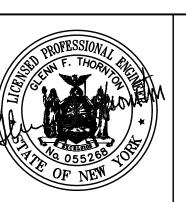FILE NAME: DETAILS.DWG	DESIGNED BY: GFT
DRAWN BY: HKT	CHECKED BY: GFT
APPROVED BY: GFT	DATE: JANUARY 2022
SCALE: NOT TO SCALE	PROJECT NO.: 21-860
SHEET NO.:	DRAWING NO.:
6 of _6_	D-2

T-01-LEROY-2-22

