

# GENESEE COUNTY PLANNING BOARD REFERRALS NOTICE OF FINAL ACTION

GCDP Referral ID

Review Date

C-02-BAT-06-24

6/13/2024

Municip	alitv
Board Na	ame

BATAVIA, C.

CITY PLANNING AND DEVELOPMENT COMM.

Applicant's Name

**Graham Corporation - Jeff Luker** 

Referral Type
Variance(s)

Site Plan Review

Area Variance(s)

Description:

Site Plan Review and Area Variance for a 30,000 sq. ft. (Approx. 250 x 116 ft.) new manufacturing building (i.e. Building 14) and associated site improvements at an existing industrial park complex.

**Building Height** 

Maximum allowed: 40 ft.

Existing: 55 ft. Proposed: 47 ft.

Location Zoning District

20 Florence Ave., Batavia

Industrial (I-1) District

### PLANNING BOARD RECOMMENDS:

### **APPROVAL**

#### **EXPLANATION:**

The proposed building should pose no significant county-wide or inter-community impacts. It is recommended that the City Planning & Development Committee forward the site plan to the City Fire Department for comments and to alert them of the presence of this building and its contents.

Felix A. Oltmi

June 13, 2024

Director

Date

If the County Planning Board disapproved the proposal, or recommends modifications, the referring agency shall NOT act contrary to the recommendations except by a vote of a majority plus one of all the members and after the adoption of a resolution setting forth the reasons for such contrary action. Within 30 days after the final action the referring agency shall file a report of final action with the County Planning Board. An action taken form is provided for this purpose and may be obtained from the Genesee County Planning Department.

#### SEND OR DELIVER TO:

GENESEE COUNTY DEPARTMENT OF PLANNING

3837 West Main Street Road Batavia, NY 14020-9404 Phone: (585) 815-7901

#### DEPARTMENT USE ONLY:

GCDP Referral # <u>C-02-BAT-06-24</u>



# \* GENESEE COUNTY \* PLANNING BOARD REFERRAL

RECEIVED Genesee County Dept. of Planning 6/4/2024

Required According to:

GENERAL MUNICIPAL LAW ARTICLE 12B, SECTION 239 L, M, N
(Please answer ALL questions as fully as possible)

1. REFERRING BOARD(S) INFORMATION 2. APPLICANT INFORMATION
Board(s) PDC and ZBA Name Jeff Luker
Address One Batavia City Centre Address 20 Florence Ave
City, State, Zip Batavia, NY 14020 City, State, Zip Batavia, NY 14020
Phone (585) 345 - 6345 Ext. Phone (585) 343 - 2216 Ext. 4361 Email jluker@graham-mfg.com
MUNICIPALITY: City Town Village of Batavia
3. Type of Referral: (Check all applicable items)
Area Variance  Use Variance  Subdivision Proposal  Zoning Text Amendments  Special Use Permit  Site Plan Review  Zoning Text Amendments  Final  Final
4. LOCATION OF THE REAL PROPERTY PERTAINING TO THIS REFERRAL:
A. Full Address 20 Florence Ave., Batavia, NY
B. Nearest intersecting road Harvester
C. Tax Map Parcel Number 84.016-1-15.1
D. Total area of the property 27.68 Acres Area of property to be disturbed 3.5 acres +/-
E. Present zoning district(s) I-1
5. REFERRAL CASE INFORMATION:  A. Has this referral been previously reviewed by the Genesee County Planning Board?
■ NO YES If yes, give date and action taken
B. Special Use Permit and/or Variances refer to the following section(s) of the present zoning ordinance and/or law BMC 190-29 A and Schedule 1
C. Please describe the nature of this request Approval to construct a 30,000 sq.ft. manufacturing building
on this industrial use complex property.
6. ENCLOSURES – Please enclose copy(s) of all appropriate items in regard to this referral
Local application Site plan Location map or tax maps Subdivision plot plans SEQR forms  Zoning text/map amendments Location map or tax maps Elevation drawings Agricultural data statement  New or updated comprehensive plan Photos Cover letter
7. CONTACT INFORMATION of the person representing the community in filling out this form (required information)
Name Douglas Randall Title Code Enf. Officer Phone (585) 345 -6327 Ext.
Address, City, State, Zip One Batavia City Centre, Batavia, NY 14020 Email drandall@batavianewyork.com



# City of Batavia Department of Public Works Bureau of Inspections

5) 245 (245 (ESE) 245 1295

One Batavia City Center, Batavia, New York 14020

(585)-345-6345

(585)-345-1385 (fax)

To:

Genesee County Planning

Planning and Development Committee

Zoning Board of Appeals

From:

Doug Randall, Code Enforcement Officer

Date:

6/3/24

Re:

20 Florence Ave. (Graham Corp.)

Tax Parcel No. 84.016-1-15.1

Zoning Use District: I-1

The applicant, Jeff Luker (Graham Corporation), has filed a Site Plan Review application, and area variance application. The project involves construction of a 30,000 sq.ft. manufacturing building in the southeast portion of this industrial use property.

## **Review and Approval Procedures:**

**County Planning Board**- Pursuant to General Municipal Law 239 m, referral to the County Planning Board is required since the property is within 500 feet of the right of way of a state road or highway.

**City Planning and Development Committee**Pursuant to section 190-44 B (1) of the zoning ordinance, the Planning and Development Committee is authorized to conduct site plan reviews.

1) BMC 190-44 D (3) and (4) Site Plan Review criteria.

**Zoning Board of Appeals-** Pursuant to BMC Sec. 190-49 of the zoning ordinance, the ZBA shall review and act on required variances.

Required variances- Area

1) BMC Sec. 190-29 A. and Schedule I

	<b>Permitted</b>	Proposed	Difference
Maximum height	40'	47'	7,

The Planning and Development Committee will be the lead agency to conduct SEQR.

CITY OF BATAVIA, NEW YORK APPLICATION FOR A BUILDING PERMIT
Application Date: 5-29-24
APPLICANT NAME JOSHUA HENDERSON PHONE 716-697-4259
APPLICANT MAILING ADDRESS 2760 KENMORE AVE, BUFFALONY 14150
APPLICANT EMAIL JHENDERSON @ MONTANTE . COM
Project Location and Information
Address of Project: 20 FLORENCE AUE BATAUIA NY 14020  Owner: GRAHAM ENGINEERING Phone: 585-343-2216  Owners Mailing Address: 20 FLORENCE AUE BATAUIA NY 14020  AG 1500600
Project Type/Describe Work  Estimated cost of work: 8.6.5 MIL
Describe project: NEW BUILD 30,000 SOFT MANUFACTURING WAREHOUSE
Contractor Information – Insurance certificates (liability & worker comp) required to be on file in our office before issuance of any permit Liability Workers Comp  GENERAL
Name & Address: MONTANTE CONSTRUCTION 2760 KENMORE AVE BUFFALONY 14150
Phone: 716-876-8899
Phone: 16-876-8899  PLUMBING (City of Batavia Licensed Plumber Required)
Phone: 116-876-8899  PLUMBING (City of Batavia Licensed Plumber Required)  Name & Address:
Phone: 16-876-8899  PLUMBING (City of Batavia Licensed Plumber Required)
Phone:
Phone: 116-876-8899  PLUMBING (City of Batavia Licensed Plumber Required)  Name & Address: Phone: Phone:
Phone:
Phone: 116-876-8899  PLUMBING (City of Batavia Licensed Plumber Required)  Name & Address: Phone: HEATING  Name & Address: MJ MECHANICAL 95 PIRSON PROT TONAWANDA NY 14150  Phone: 116-550-9493
PLUMBING (City of Batavia Licensed Plumber Required)  Name & Address:  Phone:  HEATING  Name & Address:  MJ MECHANICAL 95 PIRSON PROT TONAWANDA NY 14150  Phone:  716-550-9493  ELECTRICAL (Third Party Electrical Inspection Required)
Phone:
Phone:
Phone: 116-876-8899  PLUMBING (City of Batavia Licensed Plumber Required)  Name & Address: Phone: HEATING  Name & Address: MJ MECHANICAL 95 PIRSON PROTOTONAWANDA NY 14150  Phone: 116-550-9493  ELECTRICAL (Third Party Electrical Inspection Required)  Name & Address: FOR OFFICE USE ONLY



## City of Batavia **Bureau of Inspections**

One Batavia City Centre Batavia, NY 14020

585-345-6345

PAID

-32024

CITY OF BATAVIA CLERK-TREASURER

# **Site Plan Review Application**

Property Address 20 Florence Avenue, Batavia, NY 14020 Application date 5/30/2024

Owner:

**Graham Corporation - Jeff Luker** JLuker@graham-mfg.com Name E-mail address 20 Florence Avenue Batavia 14020 (585) 343-2216 x4361 **Mailing Address** City Zip Code Phone No.

## Describe request:

We are proposing the construction of a new 29,000 SF industrial building (Building 14) within Graham Corporation's industrial property. This project will include demolition of an existing parking lot as well as new stormwater management facilities and associated utilities. Stormwater management facilities will be designed and constructed to manage and treat runoff from future additions to this structure (Buildings 15 and 16). There are no anticipated dates of construction for Buildings 15 and 16. These are being considered for planning purposes only.

## Attachments must include the following:

- Completed building permit application
- Appropriate SEQRA documents
- 7- 11" x 17" copies of the site plan with a scale not to exceed 1 in. equals 50 ft. The site plan shall include the items listed in BMC190-44 D (2)(a-j)
- Color elevation renderings
- Site Plan Review Fee of \$250.

The Planning and Development Committee (PDC) will review applications for compliance with Batavia Municipal Code 190-44.

The review process may involve a "Sketch Plan Review". This is an optional, preliminary meeting, that provides an opportunity for the applicant to receive direction and guidance from the PDC prior to final submission. This process is especially encouraged for larger projects.

Applicant (if not the owner): Graham Corporation - Jeff Luker JLuker@graham-mfg.com Name E-mail address

20 Florence Avenue Batavia 14020 (585) 343-2216 x4361 Mailing address City Zip Code Phone No.

Signature:

Shall 6/3/14



# CITY OF BATAVIA APPLICATION TO THE ZONING BOARD OF APPEALS

	#		Application	No.:
THE STATE OF THE PARTY OF THE P			Hearing Date/Time:	
APPLICANT:	Graham Corporation - Je	eff Luker	Jluker@gra	ham-mfg.com
	Name 20 Florence Avenue		E-Mail Addre	
9∙			(585) 343 - 2	
	Street Address Batavia	NY	Phone	Fax 14020
	City	State		Zip
STATUS:	X Owner	Agent for Ow	/ner	Contracto
OWNER:	Graham Corporation - Je	ff Luker JI	uker@graham-	-mfg.com
	Name		E-Mail Addre	
	20 Florence Avenue		(585) 343 - 22	16
	Street Address		Phone	Fax
	Batavia	NY	- 110114	14020
	City	State		Zip
		Ciuio		4.17.
COLUTONO	NE DE CERTE		1. 10/4/000	
LOCATION	OF PROPERTY: 20 Florence	<u>e Avenue, Bata</u>	via. INY 14020	
	CRIPTION OF REQUEST:			
We are requ	esting a height variance o	f 55' for the prop	osed Building.	
Applicant must be the applicant to pro	present at the hearing date. Fallure to esent evidence sufficient to satisfy the 2	do so will result in the a Joning Roard of Anneal	pplication being discar	rded. It is the responsibility of
	norals, aesthetics and general welfare (			e applicant does not outweigt
			h	
$\sim$ 000 $\sim$	\(\lambda\)			
			28 - May	-7024
			-	
Applicant's Sig	gnature	D	ate	**
Owner's Signa	tuva			
Owner a bigna		L	race	
	To be Fi	lled out by Zoning O	fficer	
		,	,	
TAX PARCEL:	84.016-1-15.1 ZO	ONING DISTRICT:	I-1	FLOOD PLAIN:
TYPE OF APP	EAL: Area Variance	R	EE: \$50 (Or	ne or Two Family Use)
	Use Variance	*		All other Uses)
	· · · · · · · · · · · · · · · · · · ·		\$100 (P	(ii other Oses)
	Interpretation			
	Decision of Planning	g Committee		
Provision(s) of t	he Zoning Ordinance Appealed: _	BMC 190-	29 A and <	chalele 1
	way height of Biles		· · · · · · · · · · · · · · · · · · ·	The state of the s

## Criteria to Support Area Variance

In making its determination, the zoning Board of Appeals shall take into consideration the benefit to the applicant if the variance is granted, as weighed against the detriment to the health, safety, moral, aesthetics and welfare of the neighborhood or community. The Zoning Board of Appeals shall consider the following test, as per §81-b of the General City Law when making its determination:

Explain how the proposal conforms to EACH of the following requirements:

-/	splain now the proposal comorns to EACH of the following requirements.
TI St	Undesirable Change in nelghborhood Character. The granting of the variance will not produce an undesirable change in the neighborhood or a detriment to nearby properties. The proposed building will be within an existing industrial property and will have a use consistent with prounding buildings. The height of the proposed building will also be similar to surrounding structures. The elevation of the proposed building is lower relative to surrounding structures which will create becoming of the proposed building by trees and other structures.
2.	Alternative Cure Sought. There are no other means feasible for the applicant to pursue that would result in the difficulty being avoided or remedied, other than the granting of the area variance.
	The 55' building height is required to allow the proposed manufacturing processes to take place.  A lower building height would prevent the proposed processes from taking place.
3.	Substantiality. The requested area variance is not substantial.  The requested variance is not substantial, and will only surpass the height limit by 15', including rooftop equipment.
4,	Adverse Effect or Impact. The requested variance will not have an adverse effect or impact on the physical or environmental condition in the neighborhood or community.  The proposed building requiring a variance will be consistent with the character of the
	surrounding area and buildings. The proposed use is consistent with the surrounding facilities.
5.	Not Self-Created. The alleged difficulty existed at the time of the enactment of the provision or was created by natural force or governmental action, and was not the result of any action by the owner or the predecessors in title.
	Setting the building height above the maximum listed in the zoning code has been done to allow Graham Corporation to continue to serve their clients. This building will be used for the construction of equipment for the US government. The proposed manufacturing process would
	not beyable to take place without the requested height variance.
A	pplicant's Signature $\frac{2S-May-202y}{Date}$



#### MEMORANDUM

TO:

Douglas Randall - City of Batavia

FROM:

Thomas Bock, P.E. - CPL

DATE:

June 4, 2024

RE:

Graham Corporation Building 14 - Parking Requirements

The existing number of parking spaces within Graham Corporation's facility meets the minimum number of parking spaces required by the City of Batavia's zoning code, including spaces required for the proposed Building 14. After the construction of Building 14, 309 parking spaces will remain on site. Based on the current uses, the parking calculation is subject to two parameters:

- Manufacturing = 1 space for every 2 employees, plus 1 space for each company vehicle.
- Office = 1 space for every 300 SF of office floor area.

After the construction of Building 14, the employee count, company vehicle count, office floor area and associated number of required parking spaces will include:

- 209 manufacturing employees @ 1 space for every 2 employees =
   105 required parking spaces
- 0 company vehicles @ 1 space for each company vehicle =
  - 0 required parking spaces
- 57,000 SF of office space @ 1 space for every 300 SF of office floor area = **190 required parking spaces**

Total required parking spaces = 295 spaces

Provided number of parking spaces = 309 spaces

## Full Environmental Assessment Form Part 1 - Project and Setting

### **Instructions for Completing Part 1**

Part 1 is to be completed by the applicant or project sponsor. Responses become part of the application for approval or funding, are subject to public review, and may be subject to further verification.

Complete Part 1 based on information currently available. If additional research or investigation would be needed to fully respond to any item, please answer as thoroughly as possible based on current information; indicate whether missing information does not exist, or is not reasonably available to the sponsor; and, when possible, generally describe work or studies which would be necessary to update or fully develop that information.

Applicants/sponsors must complete all items in Sections A & B. In Sections C, D & E, most items contain an initial question that must be answered either "Yes" or "No". If the answer to the initial question is "Yes", complete the sub-questions that follow. If the answer to the initial question is "No", proceed to the next question. Section F allows the project sponsor to identify and attach any additional information. Section G requires the name and signature of the applicant or project sponsor to verify that the information contained in Part 1 is accurate and complete.

## A. Project and Applicant/Sponsor Information.

imately 29,000 square feet ie building will be located, a	t and be located within their existing associated driveways, utilities, and	
Telephone: (585) 343-	-2216	
E-Mail: JLuker@graham-mfg.com		
	<u> </u>	
State: NY	Zip Code: 14020	
Telephone: (585) 343-	l -2216 x4361	
E-Mail: JLuker@graham-mfg.com		
State: NY	Zip Code: 14020	
Telephone:	<u>-</u>	
E-Mail:		
State:	Zip Code:	
	Telephone: (585) 343 E-Mail: JLuker@grah  State: NY Telephone: (585) 343 E-Mail: JLuker@grah  State: NY Telephone: E-Mail: JLuker@grah	

## **B.** Government Approvals

B. Government Approvals, Funding, or Sponsorship. ("Funding" includes grants, loans, tax relief, and any other forms of financial assistance.)				
Government Entity	If Yes: Identify Agency and Approval(s) Required	Application Date (Actual or projected)		
a. City Counsel, Town Board, ☐Yes☑No or Village Board of Trustees				
b. City, Town or Village   ☑Yes  No Planning Board or Commission	City of Batavia Planning Board	May 2024		
c. City, Town or ✓Yes□No Village Zoning Board of Appeals	City of Batavia Zoning Board of Appeals	May 2024		
d. Other local agencies ☐Yes☑No				
e. County agencies	Genessee County Planning Board	May 2024		
f. Regional agencies ☐Yes☑No				
g. State agencies	NYSDEC-SWPPP	May 2024		
h. Federal agencies ☐Yes☑No i. Coastal Resources.				
	r the waterfront area of a Designated Inland W	aterway?	□Yes <b>☑</b> No	
<ul> <li>ii. Is the project site located in a community with an approved Local Waterfront Revitalization Program?</li> <li>iii. Is the project site within a Coastal Erosion Hazard Area?</li> </ul>				
C. Planning and Zoning				
C.1. Planning and zoning actions.				
Will administrative or legislative adoption, or ar only approval(s) which must be granted to enab  If Yes, complete sections C, F and G.  If No, proceed to question C.2 and com	nendment of a plan, local law, ordinance, rule ble the proposed action to proceed?  Inplete all remaining sections and questions in I	-	∐Yes <b>Z</b> No	
C.2. Adopted land use plans.				
a. Do any municipally- adopted (city, town, vill where the proposed action would be located?	•		<b>∠</b> Yes□No	
If Yes, does the comprehensive plan include spe would be located?	cific recommendations for the site where the p	proposed action	<b>∠</b> Yes□No	
b. Is the site of the proposed action within any local or regional special planning district (for example: Greenway; Brownfield Opportunity Area (BOA); designated State or Federal heritage area; watershed management plan; or other?)  If Yes, identify the plan(s):				
c. Is the proposed action located wholly or parti or an adopted municipal farmland protection If Yes, identify the plan(s):	ally within an area listed in an adopted municiplan?	pal open space plan,	□Yes☑No	

C.3. Zoning	
a. Is the site of the proposed action located in a municipality with an adopted zoning law or ordinance. If Yes, what is the zoning classification(s) including any applicable overlay district?  Industrial	☑ Yes ☐ No
b. Is the use permitted or allowed by a special or conditional use permit?	☐ Yes <b>Z</b> No
c. Is a zoning change requested as part of the proposed action?  If Yes,  i. What is the proposed new zoning for the site?	□Yes☑No
C.4. Existing community services.	
a. In what school district is the project site located? Batavia City School District	
b. What police or other public protection forces serve the project site?  Batavia Police Department	
c. Which fire protection and emergency medical services serve the project site?  Batavia Fire Department	
d. What parks serve the project site?  DeWitt Recreation Area, Lions Park	
D. Project Details	
D.1. Proposed and Potential Development	
a. What is the general nature of the proposed action (e.g., residential, industrial, commercial, recreational; if mixed components)? Industrial	d, include all
b. a. Total acreage of the site of the proposed action?  b. Total acreage to be physically disturbed?  c. Total acreage (project site and any contiguous properties) owned or controlled by the applicant or project sponsor?  27.68 acres  27.68 acres  27.68 acres	
c. Is the proposed action an expansion of an existing project or use?  i. If Yes, what is the approximate percentage of the proposed expansion and identify the units (e.g., acres, miles square feet)? % Units:	Yes No , housing units,
d. Is the proposed action a subdivision, or does it include a subdivision?  If Yes,  i. Purpose or type of subdivision? (e.g., residential, industrial, commercial; if mixed, specify types)	□Yes <b>Z</b> No
<ul> <li>ii. Is a cluster/conservation layout proposed?</li> <li>iii. Number of lots proposed?</li> <li>iv. Minimum and maximum proposed lot sizes? Minimum Maximum</li> </ul>	□Yes□No
e. Will the proposed action be constructed in multiple phases?  i. If No, anticipated period of construction:  ii. If Yes:  • Total number of phases anticipated  • Anticipated commencement date of phase I (including demolition)  • Anticipated completion date of final phase  • Generally describe connections or relationships among phases, including any contingencies where progred determine timing or duration of future phases:	□Yes☑No ess of one phase may

f. Does the project	ct include new resid	ential uses?	<del></del> -		☐Yes <b>Z</b> No
	nbers of units propo	sed.			[] 1 c2 [ 1/0
	One Family	Two Family	Three Family	Multiple Family (four or more)	
Initial Phase			<u></u>		
At completion					
of all phases			<del></del>		
If Yes,		new non-residentia	al construction (inclu	ding expansions)?	<b>✓</b> Yes No
i. Total number	of structures	1			
iii. Approximate	extent of building s	pace to be heated	or cooled:	116 width; and 250 length 29,000 square feet	
h. Does the propo liquids, such a If Yes,	osed action include of screation of a water	construction or oth supply, reservoir	er activities that wil , pond, lake, waste la	result in the impoundment of any agoon or other storage?	<b>Z</b> Yes□No
	e impoundment: Stor				
•	oundment, the princ	ipal source of the	water:	☐ Ground water ☐ Surface water stream	ns 🗹 Other specify:
Stormwater  iii. If other than v N/A	vater, identify the ty	pe of impounded/	contained liquids and	I their source.	
iv. Approximate	size of the proposed	l impoundment.	Volume:	0.7 million gallons; surface area:	0.57 acres
v. Dimensions o	it the proposed dam	or impounding str	ucture:	4 height: 250 length	
vi. Construction  Earth fill	method/materials for	or the proposed da	m or impounding str	ucture (e.g., earth fill, rock, wood, conc	rete):
Earin <u>IIII</u>					<del></del>
D.2. Project Op	erations	··	<del>-</del>		<u></u>
(Not including materials will r	general site prepara emain onsite)	tion, grading or in	stallation of utilities	uring construction, operations, or both? or foundations where all excavated	∏Yes <b>√</b> No
i. What is the pu	rpose of the excava	tion or dredging?		be removed from the site?	
<ul> <li>Volume</li> </ul>	(specify tons or cub lat duration of time?	ic yards):	s, etc.) is proposed to	be removed from the site?	
iii. Describe natur	re and characteristic	s of materials to b	e excavated or dredg	ed, and plans to use, manage or dispose	of them.
iv. Will there be If yes, describ	onsite dewatering o	r processing of ex	cavated materials?		Yes No
v. What is the to	tal area to be dredge	ed or excavated?		acres	
vi. What is the m	aximum area to be	worked at any one	time?	acres	
vii. What would b	e the maximum dep vation require blasti	th of excavation of	or dredging?	feet	<b>—</b>
					∐Yes ∏No
b. Would the pror	oosed action cause o	r result in alteration	on of increase or dec	rease in size of, or encroachment	Dv. Zv.
into any existing If Yes:	ng wetland, waterbo	dy, shoreline, bea	ch or adjacent area?		∏Yes <b>∏</b> No
<ul><li>i. Identify the w description):</li></ul>	retland or waterbody	which would be a	affected (by name, w	ater index number, wetland map numbe	er or geographic
		7.54			

ii. Describe how the proposed action would affect that waterbody or wetland, e.g. excavation, fill, placen alteration of channels, banks and shorelines. Indicate extent of activities, alterations and additions in so	nent of structures, or quare feet or acres:
iii. Will the proposed action cause or result in disturbance to bottom sediments?  If Yes, describe:	∐Yes∏No
iv. Will the proposed action cause or result in the destruction or removal of aquatic vegetation?	☐Yes☐No
If Yes:  • acres of aquatic vegetation proposed to be removed:	
<ul> <li>acres of aquatic vegetation proposed to be removed:</li> <li>expected acreage of aquatic vegetation remaining after project completion;</li> </ul>	
purpose of proposed removal (e.g. beach clearing, invasive species control, boat access):	
proposed method of plant removal:	
if chemical/herbicide treatment will be used, specify product(s):	
v. Describe any proposed reclamation/mitigation following disturbance:	
c. Will the proposed action use, or create a new demand for water?	<b>✓</b> Yes □No
If Yes:	<b>₩</b> ] Yes <u>I</u> No
i. Total anticipated water usage/demand per day: 1,597 gallons/day	
ii. Will the proposed action obtain water from an existing public water supply?	<b>Z</b> Yes □No
f Yes:	
Name of district or service area: City of Batavia	
<ul> <li>Does the existing public water supply have capacity to serve the proposal?</li> </ul>	<b>∠</b> Yes□ No
• Is the project site in the existing district?	<b>∠</b> Yes  No
Is expansion of the district needed?	☐ Yes 🗹 No
Do existing lines serve the project site?	✓ Yes ☐ No
iii. Will line extension within an existing district be necessary to supply the project? f Yes:	□Yes <b>Z</b> No
Describe extensions or capacity expansions proposed to serve this project:	•
Source(s) of supply for the district:	
iv. Is a new water supply district or service area proposed to be formed to serve the project site?	☐ Yes <b>Z</b> No
f, Yes:	1 63 2 1 10
Applicant/sponsor for new district:	
Date application submitted or anticipated:	
Proposed source(s) of supply for new district:	
v. If a public water supply will not be used, describe plans to provide water supply for the project:	
vi. If water supply will be from wells (public or private), what is the maximum pumping capacity:	gallons/minute.
I. Will the proposed action generate liquid wastes?	<b>Z</b> Yes □No
f Yes:	
i. Total anticipated liquid waste generation per day:	
ii. Nature of liquid wastes to be generated (e.g., sanitary wastewater, industrial; if combination, describe a	ill components and
approximate volumes or proportions of each):  unitary Wastewater, Flush Tank, parts cleaner	
ii. Will the proposed action use any existing public wastewater treatment facilities?	<b>∠</b> Yes □No
If Yes:  Name of wastewater treetment plant to be used. Batavia Wastewater Treetment Plant	
<ul> <li>Name of wastewater treatment plant to be used: Batavia Wastewater Treatment Plant</li> <li>Name of district: City of Batavia</li> </ul>	
Does the existing wastewater treatment plant have capacity to serve the project?	ZIV Chi
Is the project site in the existing district?	<b>☑</b> Yes □No <b>☑</b> Yes □No
Is expansion of the district needed?	¥Z] Yes ∐No ∐Yes ZNo
supulsion of the district needed:	T I ES MINO

<ul> <li>Do existing sewer lines serve the project site?</li> </ul>	✓ Yes  ☐ No
<ul> <li>Will a line extension within an existing district be necessary to serve the project?</li> </ul>	Yes No
If Yes:	
<ul> <li>Describe extensions or capacity expansions proposed to serve this project:</li> </ul>	
	<del></del>
iv. Will a new wastewater (sewage) treatment district be formed to serve the project site?	□Yes <b>☑</b> No
If Yes:	
Applicant/sponsor for new district:	
Date application submitted or anticipated:	
What is the receiving water for the wastewater discharge?	
v. If public facilities will not be used, describe plans to provide wastewater treatment for the project, including sp	ecifying proposed
receiving water (name and classification if surface discharge or describe subsurface disposal plans):	
vi. Describe any plans or designs to capture, recycle or reuse liquid waste:	
e. Will the proposed action disturb more than one acre and create stormwater runoff, either from new point	<b>Z</b> Yes □ No
sources (i.e. ditches, pipes, swales, curbs, gutters or other concentrated flows of stormwater) or non-point source (i.e. sheet flow) during construction or post construction?	
If Yes:	
i. How much impervious surface will the project create in relation to total size of project parcel?	
Square feet or 2.7 acres (impervious surface)	
Square feet or 27.68 acres (parcel size)	
ii. Describe types of new point sources, Building and driveways	
was been too sypes of here point outroos.	·
iii. Where will the stormwater runoff be directed (i.e. on-site stormwater management facility/structures, adjacen	t properties
groundwater, on-site surface water or off-site surface waters)?	r properties,
On-site stormwater management facilities	
	<del></del>
If to surface waters, identify receiving water bodies or wetlands:	
Will stormwater runoff flow to adjacent properties?	☐ Yes ☑ No
iv. Does the proposed plan minimize impervious surfaces, use pervious materials or collect and re-use stormwater	? 🔲 Yes 🖊 No
f. Does the proposed action include, or will it use on-site, one or more sources of air emissions, including fuel	<b>Z</b> Yes □ No
combustion, waste incineration, or other processes or operations?	<b>№</b> 1 c2 □ 140
If Yes, identify:	
i. Mobile sources during project operations (e.g., heavy equipment, fleet or delivery vehicles)	
General construction equipment during construction operations	
ii. Stationary sources during construction (e.g., power generation, structural heating, batch plant, crushers)	
the second secon	
iii. Stationary sources during operations (e.g., process emissions, large boilers, electric generation)	<del></del>
, and a serious generation,	
g. Will any air emission sources named in D.2.f (above), require a NY State Air Registration, Air Facility Permit,	
or Federal Clean Air Act Title IV or Title V Permit?	□Yes <b>☑</b> No
If Yes:	
i. Is the project site located in an Air quality non-attainment area? (Area routinely or periodically fails to meet	□Yes□No
ambient air quality standards for all or some parts of the year)	
ii. In addition to emissions as calculated in the application, the project will generate:	
•Tons/year (short tons) of Carbon Dioxide (CO <sub>2</sub> )	
•Tons/year (short tons) of Nitrous Oxide (N <sub>2</sub> O)	
•Tons/year (short tons) of Perfluorocarbons (PFCs)	
•Tons/year (short tons) of Sulfur Hexafluoride (SF <sub>6</sub> )	
•Tons/year (short tons) of Carbon Dioxide equivalent of Hydroflourocarbons (HFCs)	
Tons/year (short tons) of Hazardous Air Pollutants (HAPs)	

h. Will the proposed action generate or emit methane (including, but not limited to, sewage treatment plants, landfills, composting facilities)?  If Yes:	□Yes¶No
<ul> <li>i. Estimate methane generation in tons/year (metric):</li> <li>ii. Describe any methane capture, control or elimination measures included in project design (e.g., combustion to g electricity, flaring):</li> </ul>	enerate heat or
<ul> <li>i. Will the proposed action result in the release of air pollutants from open-air operations or processes, such as quarry or landfill operations?</li> <li>If Yes: Describe operations and nature of emissions (e.g., diesel exhaust, rock particulates/dust):</li> </ul>	∏Yes <b>∑</b> No
<ul> <li>j. Will the proposed action result in a substantial increase in traffic above present levels or generate substantial new demand for transportation facilities or services?</li> <li>If Yes: <ul> <li>i. When is the peak traffic expected (Check all that apply):</li></ul></li></ul>	Yes.
<ul> <li>iii. Parking spaces: Existing Proposed Net increase/decrease</li></ul>	☐Yes☐No access, describe: ☐Yes☐No ☐Yes☐No ☐Yes☐No ☐Yes☐No
k. Will the proposed action (for commercial or industrial projects only) generate new or additional demand for energy?  If Yes:  i. Estimate annual electricity demand during operation of the proposed action:  930,000 KWH  ii. Anticipated sources/suppliers of electricity for the project (e.g., on-site combustion, on-site renewable, via grid/sother):  National Grid  iii. Will the proposed action require a new, or an upgrade, to an existing substation?	☐Yes☐No
1. Hours of operation. Answer all items which apply.       ii. During Operations:         i. During Construction:       ii. During Operations:         • Monday - Friday:       6am - 5pm       • Monday - Friday:       7am-3:30pm & 4pm-2         • Saturday:       N/A       • Saturday:       N/A         • Sunday:       N/A       • Sunday:       N/A         • Holidays:       N/A       • Holidays:       N/A	:30am

m.	Will the proposed action produce noise that will exceed existing ambient noise levels during construction,	✓ Yes □No
	operation, or both?	
•	/es:	
	Provide details including sources, time of day and duration:	
Gen	eral noise and disturbances from construction vehicles during construction operations, 7am-5pm	
	Will the proposed action remove existing natural barriers that could act as a noise barrier or screen?	☐ Yes <b>Z</b> No
	Describe:	
n.	Will the proposed action have outdoor lighting?	✓ Yes □No
	yes:	
	Describe source(s), location(s), height of fixture(s), direction/aim, and proximity to nearest occupied structures:	
Ligh	ting on exterior of building	
•		
ii.	Will proposed action remove existing natural barriers that could act as a light barrier or screen?	☐ Yes <b>Z</b> No
	Describe:	
0.	Does the proposed action have the potential to produce odors for more than one hour per day?	☑ Yes □ No
	If Yes, describe possible sources, potential frequency and duration of odor emissions, and proximity to nearest	
	occupied structures:	
Gen	eral odors from construction vehicles during construction operations; 7am-5pm	
		<del></del>
	Will the proposed action include any hulls storage of natural sum (combined consists of court 1,100 cells as)	□ v□N.
	Will the proposed action include any bulk storage of petroleum (combined capacity of over 1,100 gallons) or chemical products 185 gallons in above ground storage or any amount in underground storage?	☐ Yes ☑ No
	Yes:	
	Product(s) to be stored  Volume(s) per unit time (e.g., month, year)	
	Volume(s) per unit time (e.g., month, year)	
ш.	Generally, describe the proposed storage facilities:	
	Will the proposed action (commercial, industrial and recreational projects only) use pesticides (i.e., herbicides,	☐ Yes <b>☑</b> No
	insecticides) during construction or operation?	
	Yes:	
	i. Describe proposed treatment(s):	
	i. Will the proposed action use Integrated Pest Management Practices?	☐ Yes ☐ No
	Will the proposed action (commercial or industrial projects only) involve or require the management or disposal	☐ Yes ☑No
(	of solid waste (excluding hazardous materials)?	
If	Yes:	
i	Describe any solid waste(s) to be generated during construction or operation of the facility:	
	• Construction: tons per (unit of time)	
	• Operation: tons per (unit of time)	
ii	Operation: tons per (unit of time)  Describe any proposals for on-site minimization, recycling or reuse of materials to avoid disposal as solid waste	•
	• Construction:	•
	- College William	
	• Operation:	
	Operation.	<del></del>
;;;	Proposed disposal methods/facilities for solid waste generated on-site:	
111.		
	Construction:	
	Operation:	

<ul><li>s. Does the proposed action include construction or modi</li><li>If Yes:</li><li>i. Type of management or handling of waste proposed</li></ul>		-	Yes 🛮 No
	for the site (e.g., recycling	-	g, iandiiii, or
ii. Anticipated rate of disposal/processing:			
• Tons/month, if transfer or other non-o		ent, or	
• Tons/hour, if combustion or thermal	treatment		
iii. If landfill, anticipated site life:	years		
<ul><li>iii. If landfill, anticipated site life:</li><li>t. Will the proposed action at the site involve the commer waste?</li></ul>	rcial generation, treatment,	storage, or disposal of hazard	ous Yes <b>Z</b> No
If Yes:			
i. Name(s) of all hazardous wastes or constituents to be	generated, handled or man	aged at facility:	
	<del></del>		
ii. Generally describe processes or activities involving h	azardous wastes or constitu	uents:	
iii. Specify amount to be handled or generated to	ons/month		
iv. Describe any proposals for on-site minimization, rec	yeling or reuse of nazardou	is constituents:	
v. Will any hazardous wastes be disposed at an existing	offsite hazardous waste fa	cility?	□Yes□No
If Yes: provide name and location of facility:			
If No: describe proposed management of any hazardous	wastes which will not be se	ent to a hazardous waste facilit	V.
11 110. desertoe proposed management of any nazardous	wastes which will not be se	in to a nazardous waste racint	у.
E. Site and Setting of Proposed Action			
E.1. Land uses on and surrounding the project site			
a. Existing land uses.	tata		
i. Check all uses that occur on, adjoining and near the ☐ Urban ☑ Industrial ☐ Commercial ☐ Resid	project site. Jential (suburban) - 🔲 Ru	ral (non-farm)	
☐ Forest ☐ Agriculture ☐ Aquatic ☐ Other	(specify):	rai (non-iaini)	
ii. If mix of uses, generally describe:	· · · · · · · · · · · · · · · · · · ·		
	<del></del>		
b. Land uses and covertypes on the project site.			
Land use or	Current	Acreage After	Change
Covertype	Acreage	Project Completion	(Acres +/-)
Roads, buildings, and other paved or impervious surfaces	16.50	18.40	+1.9
Forested	5.43	5.43	0
Meadows, grasslands or brushlands (non- agricultural, including abandoned agricultural)			
Agricultural			
(includes active orchards, field, greenhouse etc.)			
Surface water features			
(lakes, ponds, streams, rivers, etc.)			
Wetlands (freshwater or tidal)			
Non-vegetated (bare rock, earth or fill)		1	
Other	····		
Describe: Grass Lawn	5.75	3.85	-1.9

c. Is the project site presently used by members of the community for public recreation?  i. If Yes: explain:	□Yes☑No
d. Are there any facilities serving children, the elderly, people with disabilities (e.g., schools, hospitals, licensed day care centers, or group homes) within 1500 feet of the project site?  If Yes,  i. Identify Facilities:	□Yes <b>☑</b> No
e. Does the project site contain an existing dam?  If Yes:  i. Dimensions of the dam and impoundment:  Dam height: Dam length:  Dam length: feet	∐Yes <b>⊠</b> No
Surface area:     acres	
Volume impounded: gallons OR acre-feet  ii. Dam's existing hazard classification:  iii. Provide date and summarize results of last inspection:	
f. Has the project site ever been used as a municipal, commercial or industrial solid waste management facility, or does the project site adjoin property which is now, or was at one time, used as a solid waste management facility or left yes:	□Yes <b>☑</b> No ity?
<ul> <li>i. Has the facility been formally closed?</li> <li>If yes, cite sources/documentation:</li> </ul>	∐Yes∐ No
ii. Describe the location of the project site relative to the boundaries of the solid waste management facility:	<del> </del>
iii. Describe any development constraints due to the prior solid waste activities:	
g. Have hazardous wastes been generated, treated and/or disposed of at the site, or does the project site adjoin property which is now or was at one time used to commercially treat, store and/or dispose of hazardous waste? If Yes:	□Yes <b>☑</b> No
i. Describe waste(s) handled and waste management activities, including approximate time when activities occurre	d:
h. Potential contamination history. Has there been a reported spill at the proposed project site, or have any remedial actions been conducted at or adjacent to the proposed site?  If Yes:	✓Yes No
<ul> <li>i. Is any portion of the site listed on the NYSDEC Spills Incidents database or Environmental Site</li> <li>Remediation database? Check all that apply:</li> </ul>	<b>✓</b> Yes□No
<ul> <li>✓ Yes – Spills Incidents database</li> <li>☐ Yes – Environmental Site Remediation database</li> <li>☐ Neither database</li> </ul> Provide DEC ID number(s): Provide DEC ID number(s):	
ii. If site has been subject of RCRA corrective activities, describe control measures:	
iii. Is the project within 2000 feet of any site in the NYSDEC Environmental Site Remediation database? If yes, provide DEC ID number(s): 819008, V00677, C819022	<b>∠</b> Yes□No
iv. If yes to (i), (ii) or (iii) above, describe current status of site(s):  920530, 0001811, & 0404276 - Listed as closed  819008 & V00677 - Listed as "N", No further action at this time	
C819022 - Listed as "A", Active and is located on the North side of E Main Street (22-40 Clinton Street)	

v. Is the project site subject to an institutional control limiting property uses?		☐ Yes <b>Z</b> No
<ul> <li>If yes, DEC site ID number:</li> <li>Describe the type of institutional control (e.g., deed restriction or easement):</li> </ul>		
<ul> <li>Describe the type of institutional control (e.g., deed restriction or easement):</li> <li>Describe any use limitations:</li> </ul>	_	
Describe any engineering controls:		
<ul> <li>Will the project affect the institutional or engineering controls in place?</li> </ul>		☐ Yes ☐ No
• Explain:		
E.2. Natural Resources On or Near Project Site		
a. What is the average depth to bedrock on the project site?	5 feet	
b. Are there bedrock outcroppings on the project site?		☐ Yes <b>Z</b> No
If Yes, what proportion of the site is comprised of bedrock outcroppings?	%	
c. Predominant soil type(s) present on project site:  PhB - Palmyra Gravelly Loam	100 %	
	%	
d. What is the average depth to the water table on the project site? Average: >6.5 fe	et	
e. Drainage status of project site soils:  Well Drained: 100 % of site		
☐ Moderately Well Drained: % of site		
Poorly Drained% of site		
f. Approximate proportion of proposed action site with slopes: 0-10%:	100 % of site	
☐ 10-15%: ☐ 15% or greater:	% of site % of site	
g. Are there any unique geologic features on the project site?		☐Yes <b>Z</b> No
If Yes, describe:		
h. Surface water features.		<u> </u>
<ul> <li>i. Does any portion of the project site contain wetlands or other waterbodies (including stroponds or lakes)?</li> </ul>	eams, rivers,	□Yes☑No
ii. Do any wetlands or other waterbodies adjoin the project site?		∐Yes√No
If Yes to either i or ii, continue. If No, skip to E.2.i.		
iii. Are any of the wetlands or waterbodies within or adjoining the project site regulated by state or local agency?	any federal,	☐Yes <b>Z</b> No
<ul> <li>iv. For each identified regulated wetland and waterbody on the project site, provide the following.</li> <li>Streams: Name</li> </ul>	_	
Lakes or Ponds: Name	Classification	
Wetlands: Name	Approximate Size	
v. Are any of the above water bodies listed in the most recent compilation of NYS water qu	ıality-impaired	□Yes <b>☑</b> No
waterbodies?  If yes, name of impaired water body/bodies and basis for listing as impaired:		
i. Is the project site in a designated Floodway?		□Yes <b>☑</b> No
j. Is the project site in the 100-year Floodplain?		□Yes <b>☑</b> No
k. Is the project site in the 500-year Floodplain?		□Yes <b>☑</b> No
1. Is the project site located over, or immediately adjoining, a primary, principal or sole sou	rce aquifer?	<b>✓</b> Yes □No
If Yes:  i. Name of aquifer: Principal Aquifer, Primary Aquifer		
,		

n. Does the project site contain a designated significant natural community?  If Yes:  i. Describe the habitat/community (composition, function, and basis for designation):  iii. Source(s) of description or evaluation:  iii. Extent of community/habitat:  • Currently:  • Following completion of project as proposed:  • Gain or loss (indicate + or -):  o. Does project site contain any species of plant or animal that is listed by the federal go endangered or threatened, or does it contain any areas identified as habitat for an enda if Yes:  i. Species and listing (endangered or threatened):  p. Does the project site contain any species of plant or animal that is listed by NYS as a special concern?  If Yes:  i. Species and listing:  q. Is the project site or adjoining area currently used for hunting, trapping, fishing or she if yes, give a brief description of how the proposed action may affect that use:  E.3. Designated Public Resources On or Near Project Site  a. Is the project site, or any portion of it, located in a designated agricultural district cert Agriculture and Markets Law, Article 25-AA, Section 303 and 304?  If Yes, provide county plus district name/number:  b. Are agricultural lands consisting of highly productive soils present?  i. If Yes: acreage(s) on project site?  ii. Source(s) of soil rating(s):  c. Does the project site contain all or part of, or is it substantially contiguous to, a regis Natural Landmark?  If Yes:  i. Nature of the natural landmark:  Biological Community  Geolog  ii. Provide brief description of landmark, including values behind designation and application and application and applications.		
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<ul> <li>a. Is the project site, or any portion of it, located in a designated agricultural district cert Agriculture and Markets Law, Article 25-AA, Section 303 and 304? If Yes, provide county plus district name/number:</li> <li>b. Are agricultural lands consisting of highly productive soils present? <ol> <li>i. If Yes: acreage(s) on project site?</li> <li>ii. Source(s) of soil rating(s):</li> </ol> </li> <li>c. Does the project site contain all or part of, or is it substantially contiguous to, a regis Natural Landmark? <ol> <li>If Yes:</li> <li>i. Nature of the natural landmark:</li> <li>Biological Community</li> <li>Geological Provide brief description of landmark, including values behind designation and appropriate the project site of the project site of landmark, including values behind designation and appropriate the project site of the project site of landmark, including values behind designation and appropriate the project site of landmark, including values behind designation and appropriate the project site of landmark.</li> </ol></li></ul>		
Agriculture and Markets Law, Article 25-AA, Section 303 and 304?  If Yes, provide county plus district name/number:  b. Are agricultural lands consisting of highly productive soils present?  i. If Yes: acreage(s) on project site?  ii. Source(s) of soil rating(s):  c. Does the project site contain all or part of, or is it substantially contiguous to, a regis Natural Landmark?  If Yes:  i. Nature of the natural landmark:   Biological Community   Geolog  ii. Provide brief description of landmark, including values behind designation and appropriate the state of		
<ul> <li>i. If Yes: acreage(s) on project site?</li> <li>ii. Source(s) of soil rating(s):</li> <li>c. Does the project site contain all or part of, or is it substantially contiguous to, a regis Natural Landmark?</li> <li>If Yes: <ul> <li>i. Nature of the natural landmark:</li> <li>ii. Provide brief description of landmark, including values behind designation and appropriate in the project site.</li> </ul> </li> </ul>		□Yes <b>Z</b> No
Natural Landmark?  If Yes:  i. Nature of the natural landmark:		∐Yes <b>Z</b> No
	ogical Feature pproximate size/extent:	∐Yes <b>Z</b> INo
d. Is the project site located in or does it adjoin a state listed Critical Environmental Art If Yes:  i. CEA name:  ii. Basis for designation:  iii. Designating agency and date:		

e. Does the project site contain, or is it substantially contiguous to, a building, archaeological site, or district which is listed on the National or State Register of Historic Places, or that has been determined by the Commissi Office of Parks, Recreation and Historic Preservation to be eligible for listing on the State Register of Historic Places of Historic Places.  i. Nature of historic/archaeological resource: Archaeological Site Historic Building or District  ii. Name:  iii. Brief description of attributes on which listing is based:	☐ Yes☑ No ioner of the NYS laces?
f. Is the project site, or any portion of it, located in or adjacent to an area designated as sensitive for archaeological sites on the NY State Historic Preservation Office (SHPO) archaeological site inventory?	☑Yes □No
g. Have additional archaeological or historic site(s) or resources been identified on the project site?  If Yes:  i. Describe possible resource(s):  ii. Basis for identification:	□Yes <b>☑</b> No
h. Is the project site within fives miles of any officially designated and publicly accessible federal, state, or local scenic or aesthetic resource?  If Yes:  i. Identify resource:	□Yes <b>Z</b> No
<ul> <li>ii. Nature of, or basis for, designation (e.g., established highway overlook, state or local park, state historic trail or etc.):</li> <li>iii. Distance between project and resource:</li> </ul>	r scenic byway,
<ul> <li>i. Is the project site located within a designated river corridor under the Wild, Scenic and Recreational Rivers Program 6 NYCRR 666?</li> <li>If Yes: <ul> <li>i. Identify the name of the river and its designation:</li> <li>ii. Is the activity consistent with development restrictions contained in 6NYCRR Part 666?</li> </ul> </li> </ul>	Yes <b></b> No
F. Additional Information Attach any additional information which may be needed to clarify your project.  If you have identified any adverse impacts which could be associated with your proposal, please describe those in measures which you propose to avoid or minimize them.  G. Verification  I contribut that the information provided is true to the best of my knowledge.	npacts plus any
I certify that the information provided is true to the best of my knowledge.  Applicant/Sponsor Name Jeffrey D. Luker Date May 28, 2024  Signature III Manufacturing Facilities	es Engineering Managor



**Disclaimer:** The EAF Mapper is a screening tool intended to assist project sponsors and reviewing agencies in preparing an environmental assessment form (EAF). Not all questions asked in the EAF are answered by the EAF Mapper. Additional information on any EAF question can be obtained by consulting the EAF Workbooks. Although the EAF Mapper provides the most up-to-date digital data available to DEC, you may also need to contact local or other data sources in order to obtain data not provided by the Mapper. Digital data is not a substitute for agency determinations.



B.i.i [Coastal or Waterfront Area]	No
B.i.ii [Local Waterfront Revitalization Area]	No
C.2.b. [Special Planning District]	Digital mapping data are not available or are incomplete. Refer to EAF Workbook.
E.1.h [DEC Spills or Remediation Site - Potential Contamination History]	Digital mapping data are not available or are incomplete. Refer to EAF Workbook.
E.1.h.i [DEC Spills or Remediation Site - Listed]	Digital mapping data are not available or are incomplete. Refer to EAF Workbook.
E.1.h.i [DEC Spills or Remediation Site - Environmental Site Remediation Database]	Digital mapping data are not available or are incomplete. Refer to EAF Workbook.
E.1.h.iii [Within 2,000' of DEC Remediation Site]	Yes
E.1.h.iii [Within 2,000' of DEC Remediation Site - DEC ID]	819008, V00677, C819022
E.2.g [Unique Geologic Features]	No
E.2.h.i [Surface Water Features]	No
E.2.h.ii [Surface Water Features]	No
E.2.h.iii [Surface Water Features]	No
E.2.h.v [Impaired Water Bodies]	No
E.2.i. [Floodway]	Digital mapping data are not available or are incomplete. Refer to EAF Workbook.
E.2.j. [100 Year Floodplain]	Digital mapping data are not available or are incomplete. Refer to EAF Workbook.
E.2.k. [500 Year Floodplain]	Digital mapping data are not available or are incomplete. Refer to EAF Workbook.
E.2.I. [Aquifers]	Yes
E.2.I. [Aquifer Names]	Principal Aquifer, Primary Aquifer

E.2.n. [Natural Communities]	No
E.2.o. [Endangered or Threatened Species]	No
E.2.p. [Rare Plants or Animals]	No
E.3.a. [Agricultural District]	No
E.3.c. [National Natural Landmark]	No
E.3.d [Critical Environmental Area]	No
E.3.e. [National or State Register of Historic Places or State Eligible Sites]	Digital mapping data are not available or are incomplete. Refer to EAF Workbook.
E.3.f. [Archeological Sites]	Yes
E.3.i. [Designated River Corridor]	No

# **GRAHAM CORPORATION**

**BUILDING 14** 

SITE PLAN SUBMISSION

**MAY 2024** 

## **CITY OF BATAVIA GENESEE COUNTY, NEW YORK**


## CODE ENFORCEMENT OFFICER **DOUG RANDALL**

## **PLANNING & DEVELOPMENT COMMITTEE**

**DUANE PRESTON EDWARD FLYNN JIM KRENCIK JOHN OGNIBENE DAVID BEATTY** 

## **ZONING BOARD OF APPEALS**

PAUL McCARTHY JIM RUSSELL **NICK HARRIS LESLIE MOMA JEFF GILLARD** 

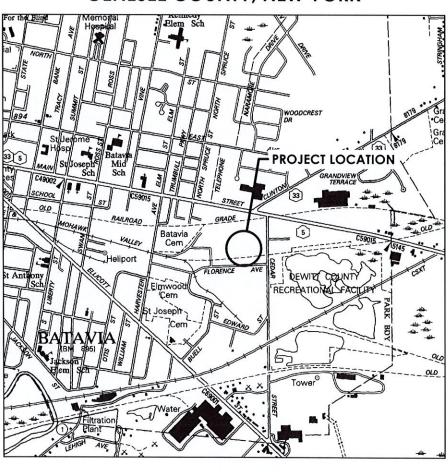

**LOCATION PLAN** 

Sheet List Table		
Sheet Number	Sheet Title	
C000	COVER SHEET	
C100	EXISTING SITE PLAN	
C101	DEMOLITION PLAN	
C200	PROPOSED SITE PLAN	
C201	PROPOSED GRADING PLAN	
C202	PROPOSED UTILITY PLAN	
C203	EROSION AND SEDIMENT CONTROL PLAN	
C300	GENERAL NOTES AND LEGEND	
C301	EROSION CONTROL NOTES	
C302	CONSTRUCTION DETAILS	
C303	CONSTRUCTION DETAILS	
L100	LANDSCAPE PLAN	
L600	LANDSCAPE DETAILS	
A201	COLOR EXTERIOR ELEVATIONS	
A202	PERSPECTIVES	



#### CPL | Architecture Engineering Planning

255 Woodcliff Drive, Suite 200 Fairport, NY 14450

#### CPLteam.com

NY ENGINEERING FIRM CERTIFICATE #018330

#### PROJECT INFORMATION

Project Number

R24.15917.00 Client Name

## **GRAHAM** CORPORATION

Project Name

## **BUILDING 14**


Project Address

20 FLORENCE AVENUE, BATAVIA, NY 14020

#### SHEET INFORMATION

AS NOTED 05/30/2024

**COVER SHEET** 

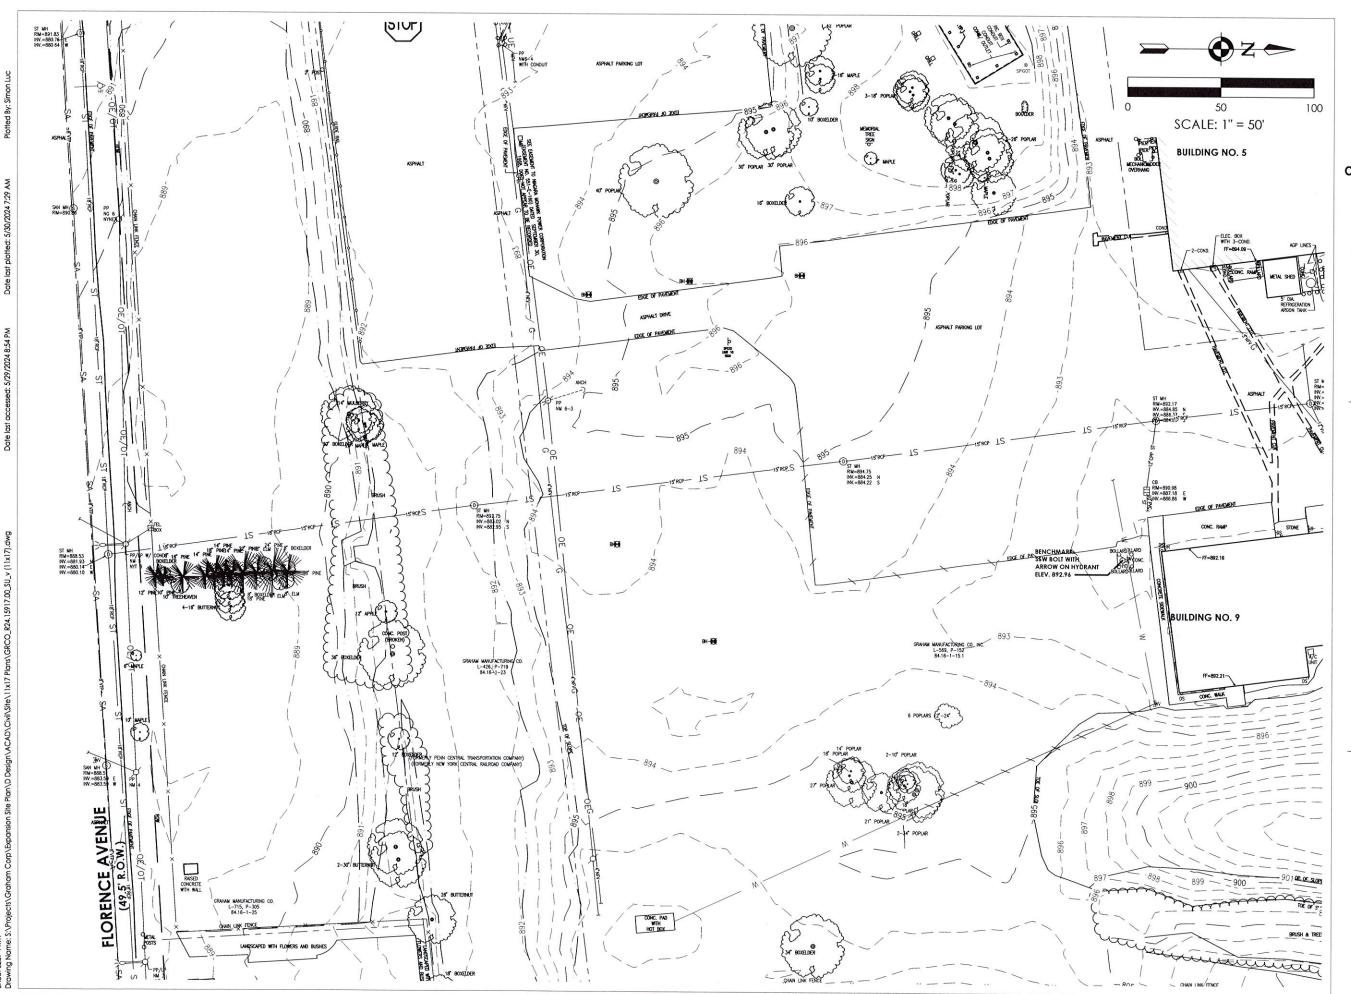



255 Woodcliff Drive, Suite 200 Fairport, NY 14450

#### CPLteam.com

NY ENGINEERING FIRM CERTIFICATE #018330

#### PROJECT INFORMATION

Project Number R24.15917.00 Client Name

## **GRAHAM CORPORATION**

Project Name

## **BUILDING 14**

Project Address

20 FLORENCE AVENUE, BATAVIA, NY 14020

#### SHEET INFORMATION

Scale Issued 1" = 50' 05/30/2024

Drawn By Checked By TRB

TRB


Drawing Title

**EXISTING SITE PLAN** 

Drawing Number

C 100



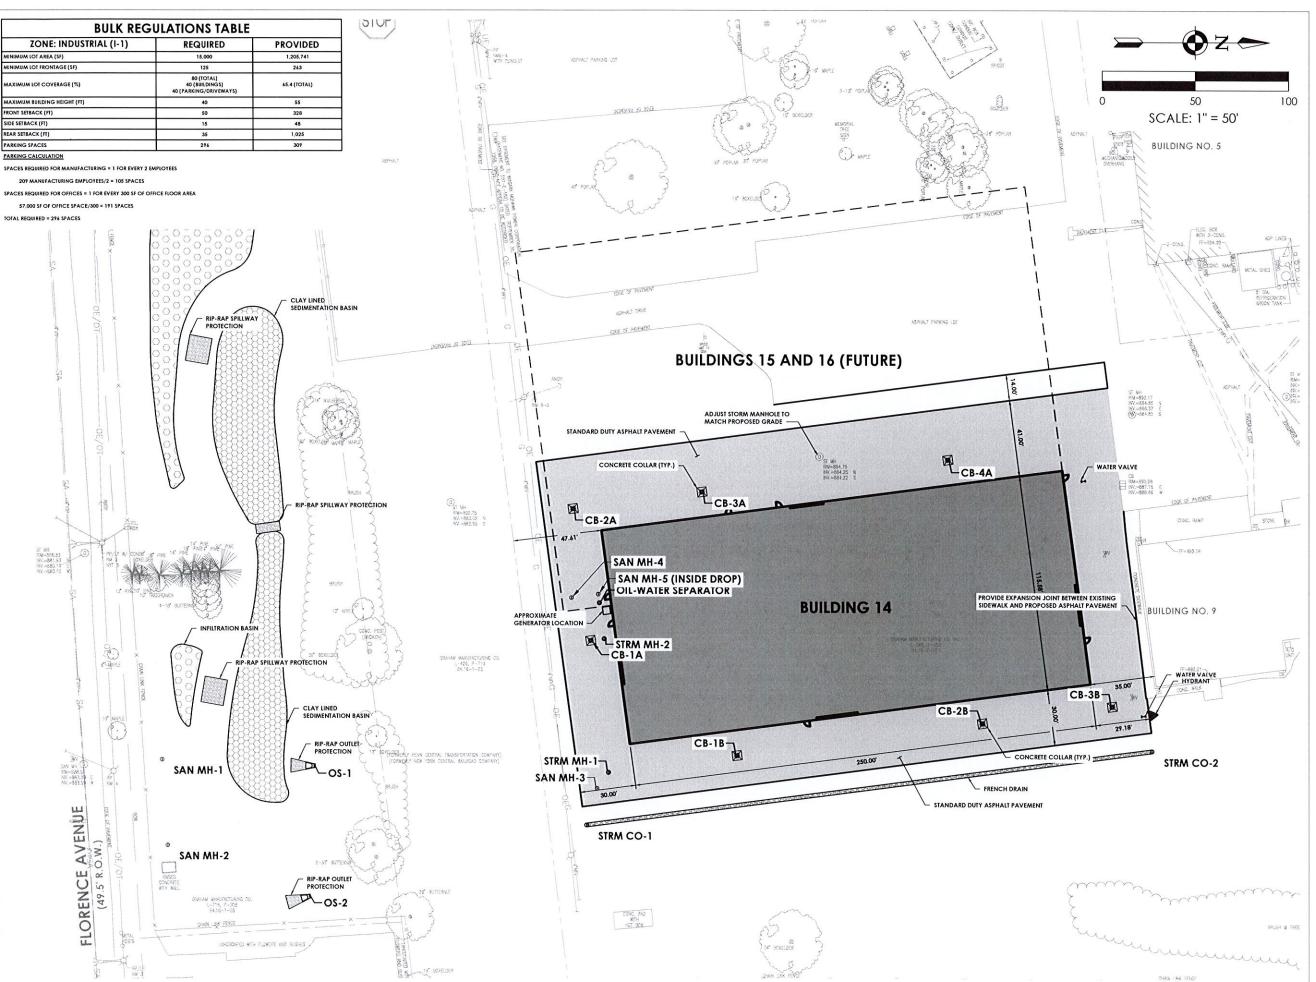



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NY ENGINEERING FIRM CERTIFICATE #018330

#### PROJECT INFORMATION

Project Number R24.15917.00

Client Name

# GRAHAM CORPORATION

Project Name

### **BUILDING 14**

Project Address

20 FLORENCE AVENUE, BATAVIA, NY 14020

#### SHEET INFORMATION

lssued Scale 05/30/2024 1" = 50'


Drawn By Checked By TRB TRB


Drawing Title

PROPOSED SITE PLAN

Drawing Number

C 200

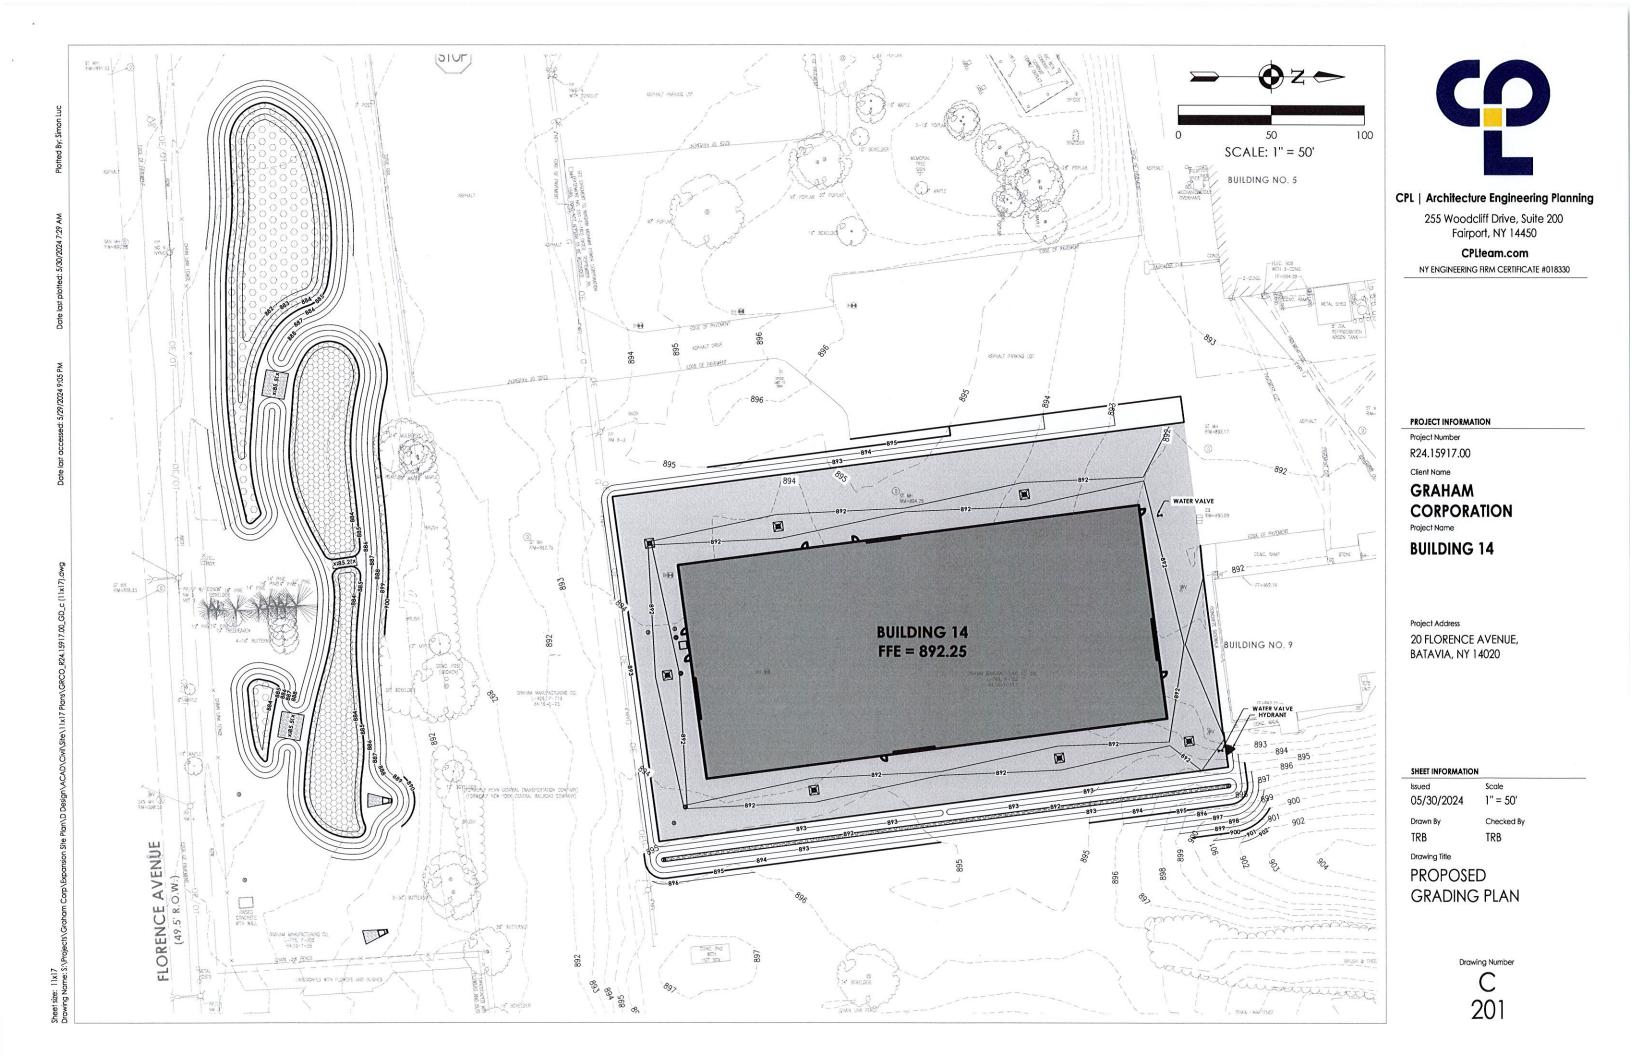

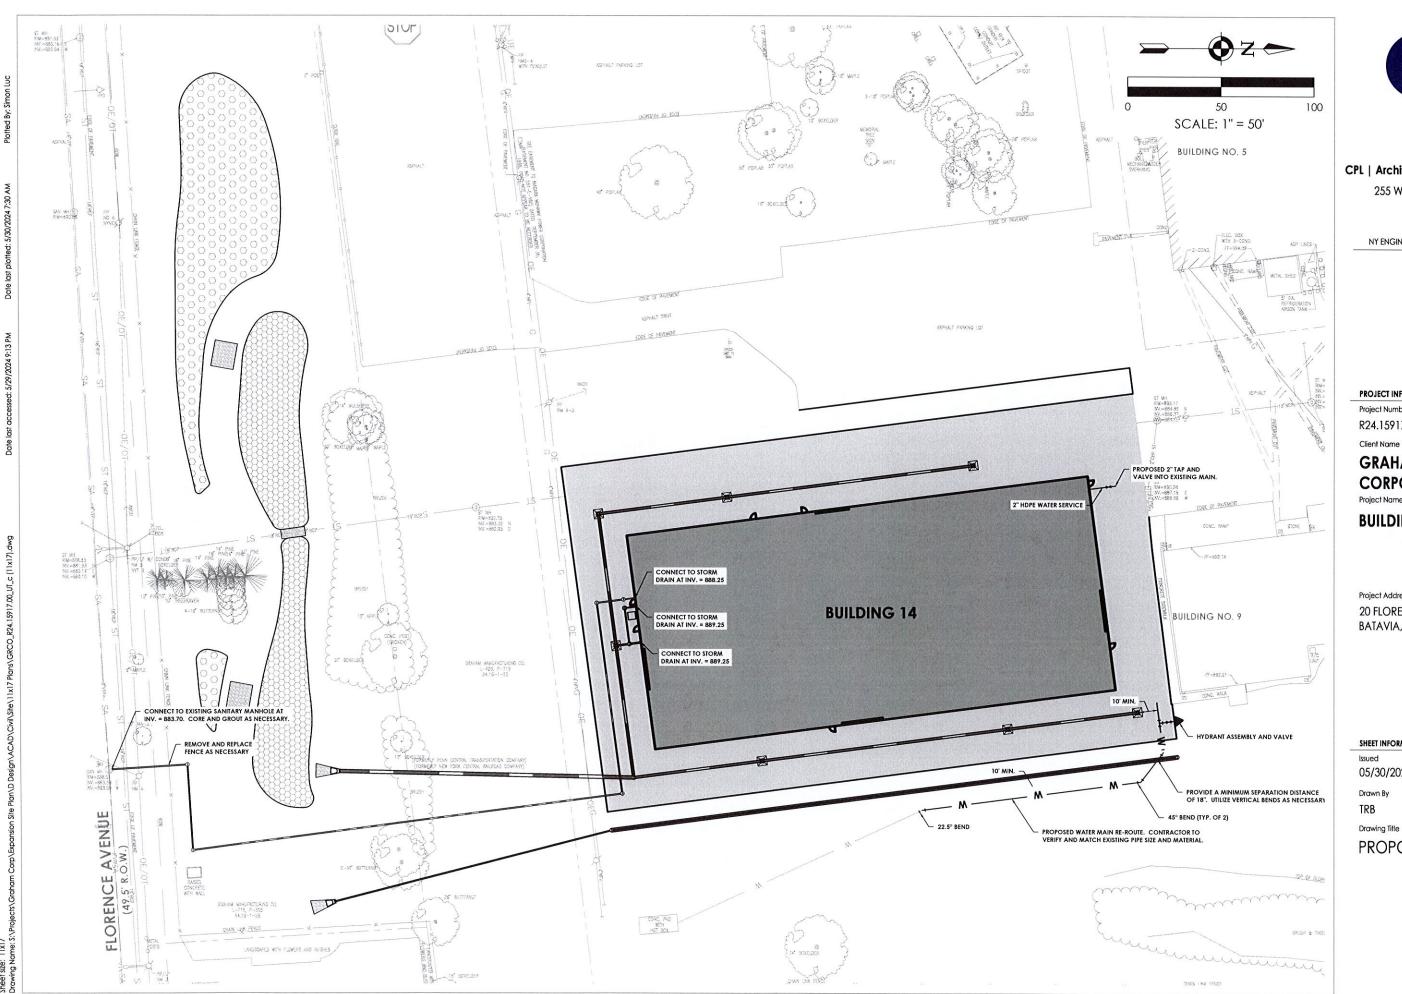



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NY ENGINEERING FIRM CERTIFICATE #018330

#### PROJECT INFORMATION

Project Number R24.15917.00

## **GRAHAM** CORPORATION

Project Name

## **BUILDING 14**

Project Address

20 FLORENCE AVENUE, BATAVIA, NY 14020

#### SHEET INFORMATION


Issued 05/30/2024 1" = 50'

Drawn By Checked By

TRB TRB

Drawing Title

PROPOSED UTILITY PLAN

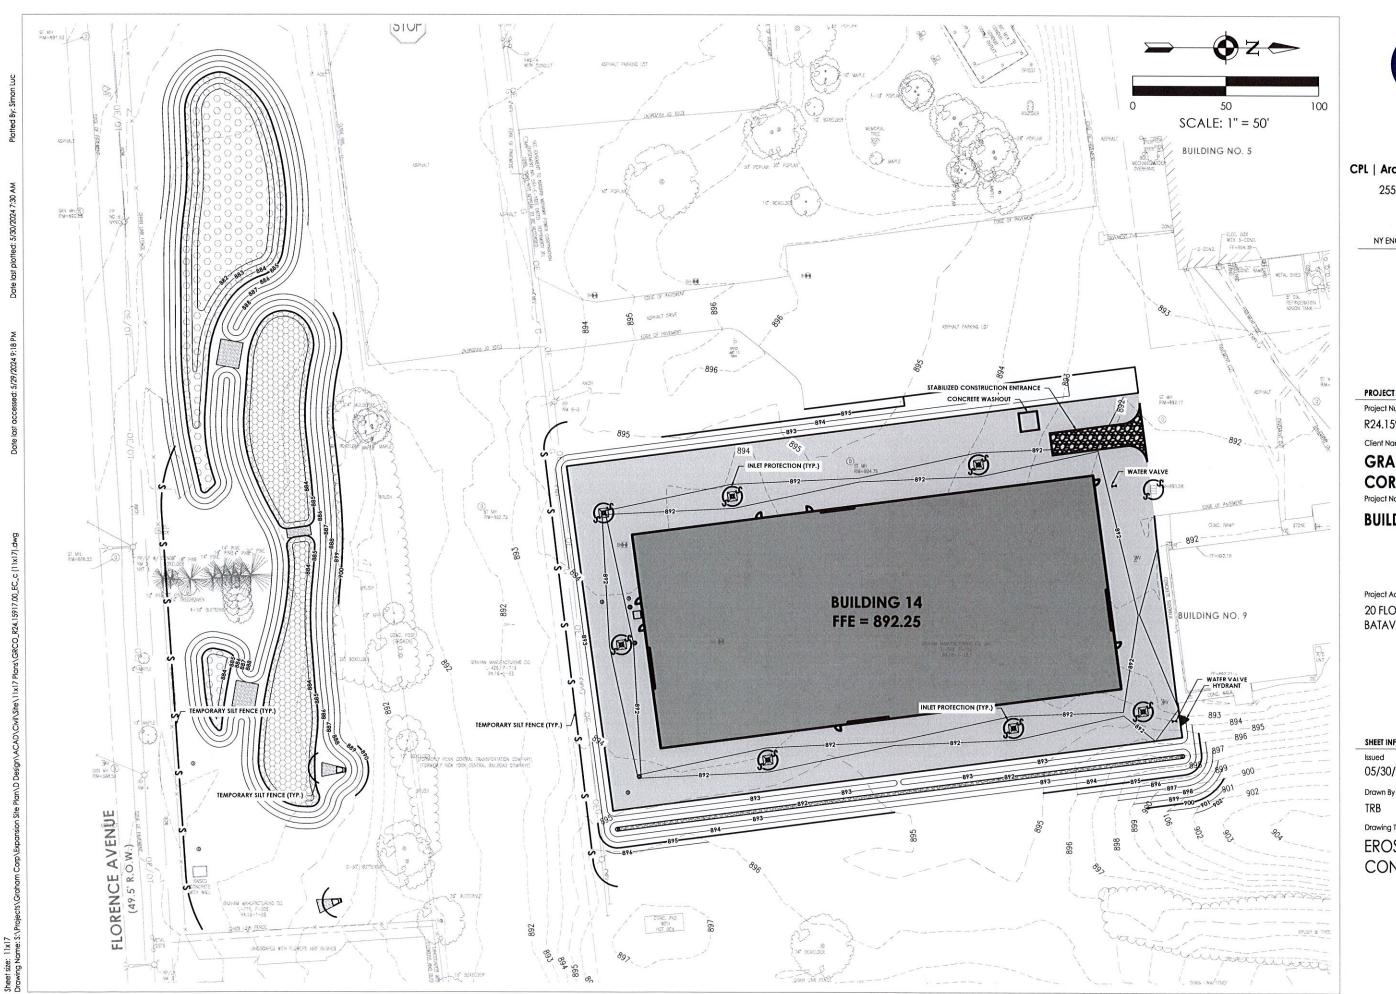



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NY ENGINEERING FIRM CERTIFICATE #018330

#### PROJECT INFORMATION

Project Number

R24.15917.00

Client Name

## **GRAHAM CORPORATION**

Project Name

## **BUILDING 14**

#### Project Address

20 FLORENCE AVENUE, BATAVIA, NY 14020

#### SHEET INFORMATION

Issued

05/30/2024 1'' = 50'

Checked By

Drawing Title

**EROSION AND SEDIMENT CONTROL PLAN** 

#### **GENERAL NOTES**

- THE LOCATIONS, SIES AND LEVATIONS OF EDITION UTILIES ARE ALSO ON INCOMATION COUNTED ST. THE SECRETES FROM EXAMINED OF THE COLOR AND INFORMATION AND INFORMATION OF THE SECRET OF THE SEC
- THE CONTRACTOR SHALL EXPOSE EXISTING UTURES, SERVICES, SERVES AND LATERALS AHEAD OF PIPE LATING OF OTHER WORK OPERATIONS SO THAT
  F MINOR ADDITIMENTS MUST BE MADE IN ELEVATION AND/OR AUDITIMENT, DUE TO INTERFERENCE, THESE CHARGES CAN BE MADE IN ADVANCE OF
  THE WORK.
- 4 SAFE AND CONTINUOUS THROUGH TRAFFIC AND INGRESS AND EGRESS FOR ADJACENT OWNER DEVEWAYS, SERVICE ROADS AND PUBLIC STREETS SHALL BE MAINTAINED THROUGHOUT THE PERIOD OF CONSTRUCTION.
- 5. THE OWNER WILL OBTAIN ALL EASEMENTS OR PERMITS OUTLINED IN THE PROJECT SPECIFICATIONS.
- 4. THE CONTRACTOR SHALL LOCATE, FLAG AND PRESERVE SURVEY MONUMENTS AND PROPERTY CORNER MARKERS
- THE CONTRACTOR SHALL HAVE A LICENSED SURVEYOR REESTABLISH ANY PROPERTY CORNERS OR SURVEY MONUMENTS DISTURBED DURING CONSTRUCTION AT NO ADDITIONAL COST TO THE OWNER.
- B. CONTRACTOR SHALL PRESERVE AND PROTECT FROM DAMAGE ALL TREES. FENCES AND OTHER OBSTACLES WITHIN THE ROW AND EASEMENT.
- CONTRACTOR SHALL RETAIN THE SERVICES OF A QUALIFIED TREE EXPERT TO REMOVE, WHERE NECESSARY, BRANCHES WHICH INTERFERE WITH THE CONSTRUCTION OPERATIONS, OR REPAIR TREES HAVING SUFFERED DAMAGE BY CONSTRUCTION ACTIVITIES. COST TO BE INCLUDED IN THE VARIOUS BUD STRANG OF the CONTRACT.
- 11. CONTRACTOR TO PROTECT NEW OR EXISTING WORK, SHEETING OR SHORING (IF REQUIRED DURING CONSTRUCTION) AT NO EXTRA COST TO THE OWNER.
- 12. WHIBIVER MAILBOXES, POSTS, FINGES, SHEUBERY, ETC. ARE IN CONFLICT WITH THE PROPOSED CONSTRUCTION, THEY SHALL BE REMOVED AND RESET AS ORDERED BY THE ENGINEER. COST TO BE INCLUDED IN THE VARIOUS SID TIEMS OF THE CONTRACT.
- 14. THE CONTRACTOR SHALL CONFORM TO ALL CONDITIONS OF ANY APPLICABLE EASEMENTS OR PERMITS
- 15. ALL MATERIALS AND EQUIPMENT MUST BE STORED WITHIN THE CONFINES OF THE CONSTRUCTION AREA, MATERIALS, EQUIPMENT, AND VEHICLES ARE NOT TO BE STORED OF PARKED WITHIN THE BIGHT, OF WAY.

#### **DEMOLITION NOTES**

- AT THE COMMENCEMENT OF EXTEROE DEMOLITION WORK OR ANY OTHER EXTEROR WORK, THE CONTRACTOR SHALL PROVIDE TEMPORATE ENCIOUSIER FINCE. THE CONTRACTOR SHALL MAINTAIN AND ADJUST THE TEMPORATE FINCING THROUGHOUT THE DUBATION OF DEMOLITION AND CONSTRUCTION ACTIVITIES UPIN ALL STREEDS ACTIVITIES AS CONJUSTED OF UNITS DIRECTOR OTHERWISE STREEDS THAT STREEDS ACTIVITIES AS CONJUSTED OF UNITS DIRECTOR OTHERWISE STREEDS THAT STREEDS ACTIVITIES.
- WHEN REMOVING PAYEMENT OR CURES THAT ARE ADJACENT TO PAYEMENT, CURBING OR STRUCTURES THAT ARE TO REMAIN, FULL DEPTH SAW CUT THE PAYEMENT TO BE REMOVED UNLESS SEPARATED BY AN EXISTING ISOLATION JOINT.
- 3. PROTECT ALL UTILITIES, EXISTING DEVICES & ROAD SIGNS THAT ARE TO REMAIN.
- 4. STORE ON-SITE AND REUSE PARKING/BUILDING/STREET SIGHS WHEREVER POSSIBLE. REUSED SIGHS TO BE MOUNTED TO NEW SIGH POSTS. PROPERLY DISPOSE OF ALL REMAINING SIGHS AND POSTS THAT WERE NOT REUSED.
- REMOVE & PROPERLY DISPOSE OF ALL TREES, BRUSH & DEBRIS WITHIN LIMITS OF DISTURBANCE AS DESIGNATED (CLEARING AND GRUBBING SHALL INCLUDE THE REMOVAL AND DISPOSAL OF ALL ORGANIC MATERIAL INCLUDING STUMPS AND ROOT SYSTEMS UNDER PROPOSED PAYMAPHY ALL SIEPS TO SHAMIN ARE TO BE PROTECTED PROM DAMAGE.
- REMOVE & STOCK PILE ON SITE ALL TOP SOIL WITHIN AREA OF DISTURBANCE FOR LATER USE. EXCESS TOPSOIL TO BE STOCKPILED AT DESIGNATED LOCATION. THE TOPSOIL PILE LOCATION SHALL BE SURROUNDED WITH SILT FENCE AND SEEDED WITH LAWIN GRASS SEED MIXTURE.
- COORDINATE WITH OWNER'S REPRESENTATIVE TO INSPECT GROUND DURING TOPSOIL REMOVAL & CLEARING AND GRUSSING PROCESS. POT MOLES RESULTING FROM TREE ROOT REMOVAL SHOULD BE BACKRILLED & COMPACTED WITH STRUCTURAL BACKRILL AS DIRECTED BY OWNER'S PRESENTATION.
- 8. PROOF ROLL THE NEWLY EXPOSED SUBGRADE IN THE PRESENCE OF OWNER'S REPRESENTATIVE. UNDERCUT UNSUITABLE SUBGRADE AS DIRECTED BY OWNER'S REPRESENTATIVE.
- P. PROTECT TREES, URILITY POLES, GUY WIRES, POSTS, EDGE OF CONCRETE WAIKS & CURB, AND ROOT SYSTEMS TO REMAIN AS NOTED, OR AS REQUIRED, PROM DAMAGE DURING CONSTRUCTION. CONTRACTOR SHALL REPAIR OR REPLACE AS NECESSARY ANY ITEM DAMAGED DURING CONSTRUCTION AT NO ADDITIONAL COST OF THE OWNER.
- 10. CONTRACTOR TO TAKE PRECAUTIONS TO PROTECT EXISTING POOTS DURING CONSTRUCTION. POOTS SHALL BE CLEAN CUT AS DIRECTED BY THE OWNER'S REPRESENTATIVE.
- 11. ALL UNDERGROUND UTSITIES AND THEIR LOCATION SHOWN HEREON ARE APPROXIMATE. CONTRACTOR IS RESPONSIBLE TO VERIFY ALL EXISTING UTURIES AND VERIFY THEIR LOCATIONS AND DEPTH FROM TO BEGINNING CONSTRUCTION. THE COMPRACTOR IS RESPONSIBLE FOR ALL REPAIRS DE SISTING UTILISES FED AMAGED BY WORK.
- 12. CONTRACTOR TO COORDINATE ALL WORK DONE RELATED TO UTILITY POLES AND OVERHEAD LINES WITH UTILITY PROVIDERS.
- 13. CONTRACTOR SHALL REMOVE ALL EXISTING UNDERGROUND UTILITIES DESIGNATED, AND FILL EXCAVATION AREA WITH STRUCTURAL FILL AND COMPACTED IN 4" LIPTS.
- 14. UNLESS OTHERWISE NOTED ON DRAWINGS, ALL FIPES AN CONDUTS TO BE ABANDONED SHALL BE CUT AND SEALED ON BOTH ENDS. ALL FIPES AND CONDUTS O'N DIAMETER OR LARGER SHALL ALSO BE FULLY FILLED WITH SAND OR FLOWABLE FILL.

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15. EXCAVAITED WASTE MATERIAL INCLUDING EXCESS SOIL SHALL BE REMOVED FROM THE SITE AND PLACE IN A LOCATION ACCEPTABLE WITH LOCAL, STATE AND PEDERAL REQUILITIONS.

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#### SEDIMENT AND EROSION CONTROL NOTES

- SEQUENT FROM THE SITE SHALL BE PREVENTED FROM DISCURRING TO ANY SUBFACE WAITE OR STORMWAITE FIRMS SYSTEM BY THE INSTALLADION OF BOSION AND SEQUENTATION CONFROL MEASURES AND PRACTICES FROR TO OR CONCURRINT WITH LAND DISTURBING ACTUMENS.
- CONTRACTOR SHALL APPOINT A FERSON TO BE RESPONSIBLE FOR ALL EROSION AND SEDWENT CONTROL MEASURES. THIS FERSON SHALL BE TRAINED IN ACCORDANCE WITH NYSDEC REQUIREMENTS FOR EROSION AND SEDWENT CONTROL ACTIVITIES.
- 4. CONSTRUCT STABILIZED CONSTRUCTION ENTRANCE IN ACCORDANCE WITH DETAIL. COOPDINATE LOCATION WITH OWNER PRIOR TO ANY ON-SITE ACTIVITIES.
- I. PROVIDE AND MAINTAIN INLET PROTECTION ON ALL EXISTING AND NEW CATCH BASINS, MANHOLES AND INLETS UNTIL DRAINAGE AREAS ARE STABILIZED, USE COMPOST RITER SOCK BY PLACE OF RITER FABRIC IN PAYED AREAS.
- PROVIDE AND MAINTAIN SILT FENCE AROUND FERMETER OF ALL WORK AREAS, EXCAVATED SOR, STOCKPILES, AND BETWEEN DIS AREAS AND DRAINAGE WAYS OR WATER BODIES. COORDINATE LOCATIONS WITH OWNER AS WORK PROGRESSES AND AREAS ARE STAB SILT FENCE TO BE INSTALLED AND ERSTRICHED (MIN "S BOOK ORGUND LEVATION). SILD SOCK MAY USED ON PAYED OF GRAVEL
- 7. ALL EXPOSED SUBGRADE AREAS INTENDED FOR PAYEMENT SHALL BE STABILIZED WITH SUBBASE STONE WITHIN THREE (3) DAYS OF EXCAVATION
  / PAYUMENT REMOVALS.
- EROSION CONTROL MEASURES SHALL BE IN PLACE PRIOR TO ANY SOIL DISTURBANCE ACTIVITIES, INCLUDING GRADING OR FILLING OPERATIONS AND INSTALLATION OF PROPOSED STRUCTURES OR UTERITIES.
- CONTRACTOR SHALL MAINTAIN EROSION CONTROL MEASURES AT ALL TIMES. IF FULL IMPLEMENTATION OF THE APPROVED FLAN DOES NOT
  PROVIDE FOR EFFECTIVE EROSION CONTROL, ADDITIONAL EROSION AND SEDMENT CONTROL MEASURES SHALL BE IMPLEMENTED.
- 10. ALL SOIL EROSION AND SEDIMENTATION CONTROL MEASURES AND PRACTICES, WHETHER TEMPORARY OR PERMANENT, SHALL BE MAINTAINED AT ALL TIMES UNTIL CONSTRUCTION IS COMPLETED AND THE WORK AREAS ARE STABILIZED.
- 11. CONSTRUCT TEMPORARY SILT FENCING ALONG BOTTOM EDGE OF ALL SLOPES AND/OR AS SHOWN, AS DESIGNATED, OR AS DIRECTED BY OWNESS REPRESENTATIVE.
- CONSTRUCT IEMPORARY STONE CHECK DAMS ALONG DITCH LINES AS SPECIFIED AND/OR AS SHOWN, AS DESIGNATED, OR AS DIRECTED BY OWNERS REPRESENTATIVE.
- ALL EROSION AND SEDMENT CONTROL MEASURES MUST BE INSPECTED AND MAINTAINED WEEKLY. CONTRACTOR SHALL KEEP ON RILE A RECORD OF THE REQUIRED INSPECTION REPORTS.
- 14. ALL DISTURBED AREAS, EXPOSED SLOPES AND SWALES SHALL BE VEGETATED (TEMPORARY SEEDED) WITHIN 14 CALENDAR DAYS FOLLOWING COMMETION OF ANY PHASE OF GRADING.
- JUTE MESH OR OTHER STABILIZATION FABRIC SHALL BE APPLIED TO ANY SLOPES GREATER THAN 19:4H IMMEDIATELY UPON COMPLETION OF GRADING ACTIVITIES. MESH OR OTHER MEASURE SHALL BE ADEQUATELY SECURED.
- 16. TEMPORARY SEEDING SHALL BE SEEDED RYE GRASS AT A RATE OF RIVE (5) LBS PER 1,000 SQUARE FEET OF AREA. CONTINUALLY REAPPLY.
  TEMPORARY SEEDING AT REST SIGN OF EROSION OR DETERIORATION OF THE SURFACE GRADE.
- 17. FERMANENT GROUND COVER SHALL BE INSTALLED ON ALL DISTURBED AREAS WITHIN 5 WORKING DAYS FOLLOWING COMPLETION OF CONSTRUCTION OF DEVELOPMENT.
- 18. ALL EROSION AND SEDMENT CONTROL MEASURES SHALL BE REMOVED COMPLETELY UPON FINAL STABILIZATION. COORDINATE TIMING OF REMOVAL WITH OWNERS REPRESENTATIVE.
- 19. CONTRACTOR SHALL FLUSH CLEAN ALL EXISTING AND NEW STORM PIPING WITHIN PROJECT LIMITS AFTER FINAL STABILIZATION IS COMPLETE.
- 20. WALKWAYS TO BE KEPT FREE AND CLEAR OR DEBRIS, REFUSE AND SILT AT ALL TIMES.
- DEBRIS, VEGETATION AND OTHER SPOILS REMOVED AS PART OF THE CONSTRUCTION ACTIVITIES SHALL BE DISPOSED OF AT UPLAND LOCATIONS ABOVE THE REACH OF HIGH WATER AND IN ACCORDANCE WITH LOCAL LAWS AND REGULATIONS. SEDWLETI DISPOSAL IN WATER BODY, WITLANDS, PROCEDURA IN STREET, PROMISED.
- 23. CONTRACTOR TO CONSTRUCT A TEMPORARY CONCRETE WASHOUT AREA ADJACENT TO EACH WORK AREA ENTRANCE.
- THE CONTROL OF DUST ORIGINATING FROM THE CONSTRUCTION OPERATIONS IS CONSIDERED A CRITICAL RESPONSIBILITY OF THE CONTRACTOR. THE ENGINEER WILL BE THE FINAL JUDGE OF THE ADEQUACY OF THE CONTRACTOR'S DUST CONTROL EFFORTS. WORK MAY BE SUPPRIVED BY THE ROMINEER UNITED ADEQUATE DUST CONTROL BY TAKEN.

#### **ASPHALT PAVEMENT & STRIPING NOTES:**

- CONTRACTOR SHALL FIELD VERFY IN THE PRESENCE OF THE OWNER'S GRANULAR MATERIAL IN
  PROPOSED A SPHALL SECTIONS. OWNER'S REPRESENTATIVE DETERMINATION SHALL BE FINAL AND
  SHODING. 3. ALL ASPHALT PAVING SHALL MEET THE LINES AND GRADES AS SHOWN ON THE CONTRACT PLAN

#### WATER MAIN TESTING AND DISINFECTION NOTES

- WATER FOR TESTING AND FLUSHING SHALL BE OBTAINED FROM EXISTING WATER SYSTEM. ARRANGEMENTS SHALL BE MADE
  WITH THE WATER DEPARTMENT FOR PAYMENT OF WATER USED.
- 2. FLUSH MAINS AND SERVICES BEFORE TESTING. MINIMUM FLUSHING VELOCITY SHALL BE 2.5 FEET PER SECOND.
- HOME STRING, SECTIONS ADJACENT ON THE SES SECTION PAGE AS EAST OWN WHILE THE SECOND.

  RUNGER ALL WATER, FOLUMENT, CONNECTIONS, PAPING, METER, MAJERING SPORES, FLOWER, AND THE MAJERING SPORES, THE SECTION OF WATER MAIN IN TO EXCELD 2002 RETRIN LINGUIS.
- TESTING SHALL MEET THE MINIMUM REQUIREMENTS OF AWWA C 440 SECTION 4, EXCEPT WHERE MORE RIGO REQUIREMENT ARE ESPACIABILISHED RY THE SECURCIATIONS. ALL PRESSURE TIESS MUST BE WITHESSED BY A VILLAGE OF INVORTAL WATER OPERATION. REPORTED AND EXPENDED OF THE VIRGORITY OF THE PRESSURE OF SOFT BY A FEW THE PRESSURE OF A MINIMUM OF THE STORY ARE THE PROPERTY OF THE PRESSURE OF SOFT BEADVE NORMAL LINE PRESSURE OF A MINIMUM OF THE STORY ARE THE PROPERTY.
- A PRELIMINARY TEST OF SO PSI ABOVE NORMAL LINE PRESSURE OR A MINMUM OF 150 PSI SHALL BE PERFORMED BY THE
  CONTRACTOR, AFTER THE PRELIMINARY TEST IS SATISFACTORY, THE WATER SYSTEM OPERATOR SHALL BE GIVEN 24 HOURS
  NOTICE, AND A PINAL TEST PERFORMED.

- TEST PRESSURE SHALL BE BASED ON THE ELEVATION OF THE LOWEST POINT UNDER TEST. PRESSURE SHALL BE APPLIED BY A PUMP CONNECTED TO THE PIPE. THE PUMP, PIPE, CONNECTIONS, GAGES, AND MEASURING DEVICES SHALL BE CALIBRATED TO THE SATISACTION OF THE ROGINEER.

- 2. THE INTERIORS OF ALL APPLIETMANCES AND SECTIONS OF WATER MAIN THAT CANNOT HORMALLY BE DISINFECTED SHALL BE TWASSED BY THE CONTRACTION, TO THE MINISTER, WITH A CONCENTIATED CHICKNESS COURTED CHICKNESS OUT OF THE CONTRACTION BY ALL SECTION OF THE CONTRACTION BY ALL SECTION BY A STATE OF THE CONTRACTION BY ALL SECTION BY A STATE OF THE CONTRACTION BY ALL SECTION BY A STATE OF THE CONTRACTION BY ALL SECTION BY A STATE OF THE CONTRACTION BY ALL SECTION BY A STATE OF THE CONTRACTION BY A STATE OF THE CONTRACTIO
- 13. WATER SAMPLES SMALL SE COLLECTED SY THE CONTRACTOR AND AMALYZED SY A NEW YORK STATE DEPARTMENT OF HARTIM APPROVID TERMOS LASIONADERY FOR EACTEROLOGICAL CONTRIT. A MINIMUM OF ONE MARKET RES 100 OF ONEN WAITER MAN AND ONE FOR EACH SET RETEIT SHALL EXCLUSION AND MARKETSE LOADING OF MARKET FAR 12 APPROVID SY THE ROWSTER AND LC D.O.M. THE HYDRANGS ARE NOT ACCEPTABLE SAMPLING DOYSET. THE WORK WILL NOT BE ACCEPTED WHILL A SEPTION IS SUMMITTION DE REGISTRES, DOWNED FOR A WAITER SAMPLE IS SATISFACTORY, AND THE SYSTEM IS READY FOR USE THE WAITER MAN SHALL NOT BE PLACED INTO MERCYCE UNTIL SO AUTHORISED SYSTEM LITHOWASTION COUNTY HEALTH DEPARTMENT.
- 14. THE MUNICIPALITY SEEDS IN DIGNIES IS REPORTED FOR CENTURE OF DISEASE WHEN SYSTEM OFFICE A CON-DISEASEMENT OF MAIN THAN THE WESTERM WAS INTERESTED IN ACCORDANCE WITH THE APPROVED DAMAN AND SPECIALISMS AND THAN THE RUSSINGS, ISSUING, AND DIGNIFICTION WAS FREGORATION AND THAN THE OFFICE OFFICE AND COUNTEMENT, BUT OFFICE OFFICE AND SEEDS AND SEEDS OFFI THE APPROVED AND THE APPROVED AND ACCORDING CONTROL SEEDING SEEDS TO THE WASTE SYSTEM OFFI AND AND CHECKED WHEN THE APPROVED AND ACCORDING CONTROL SEEDING SEEDS TO THE WASTE SYSTEM OFFI AND AND ACCORDING OWNERS ASSOCIATED AND ACCORDING THE APPROVED AND ACCORDING THE ACCORD

#### ------ DUSTING DITCH EXISTING EASEWENTS FOSTING FINCE EXISTING STONE WALL EXISTING PARCEL LINE \_\_\_\_\_\_ DISTING PARCEL SETBACK DOSTING RALIFOAD TRACKS EXISTING ROADWAY CENTERLINE Q O O EXISTING ROADWAY GUIDERAL EXISTING WETLAND EXISTING OVERHEAD ELECTRIC EXISTING OMERICAD TELEPHONE EXISTING UNDERGROUND ELECTRIC — EXISTING UNDERGROUND FUEL SYSTEM EXISTING UNDERGROUND SANITARY SEWER — EXISTING UNDERGROUND SANITARY FORCE WAIN EXISTING UNDERGROUND STEAM TRANSMISSION EXISTING UNDERGROUND STORM SEWER EXISTING UNDERGROUND TELEPHONE ABANDONED UNDERGROUND CABLE TV ARANONED UNDERGROUND ELECTRIC ABANDONED UNDERGROUND FUEL SYSTEMS ABANDONED UNDERCROUND SANITARY SEWER ABANDONED UNDERGROUND STORM SEWER ABANDONED UNDERGROUND TELEPHONE ABANDONED UNDERGROUND WATER SUPPLY



	PROPOSED	AUGNMENT CENT	ERLINE
	PROPOSED	DITCH	
	PROPOSED	SILTFENCE	
	PROPOSED	EASEMENTS	
	PROPOSED	BARB WIRE FENCE	1
	PROPOSED	CHAIN LINK FENC	t
	PROPOSED	STOCKADE FENCE	ı
	PROPOSED	STONE WALL	
	PROPOSED	PARCEL LINE	
	PROPOSED	PARCEL SETBACK	
	PROPOSED	RAILROAD TRACK	ıs.
0	PROPOSED	ROADWAY GUIDE	FRAIL
	PROPOSED	WATERBODY EDG	ŧ
	PROPOSED	WETLAND	
	PROPOSED	OVERHEAD	CABLETV
	PROPOSED	OVERHEAD	ELECTRIC
	PROPOSED	OVERHEAD	TELEPHONE
	PROPOSED	UNDERGROUND	CABLE TV
	PROPOSED	UNDERGROUND	ELECTRIC
	PROPOSED	UNDERGROUND	FUEL SYSTEMS
	PROPOSED	UNDERGROUND	NATURAG GAS
	PROPOSED	UNDERGROUND	SANITARY SEWER
	PROPOSED	UNDERGROUND	SANITARY FORCE MAIN
	PROPOSED	UNDERGROUND	STEAM TRANSMISSION
	PROPOSED	UNDERGROUND	STORM SEWER
	PROPOSED	UNDERGROUND	TELEPHONE
	PROPOSED	UNDERGROUND	WATER SUPPLY

PROPOSED PROJECT UMF UNE



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255 Woodcliff Drive, Suite 200 Fairport, NY 14450

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Drawn By

JTS

Checked By


Scale

N.T.S.

Drawing Title


**GENERAL NOTES** AND LEGEND


## VEHICLE WASH DETAIL

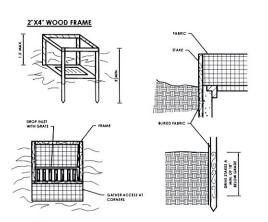

#### CONSTRUCTION SPECIFICATIONS


### FILTER FABRIC DROP INLET PROTECTION

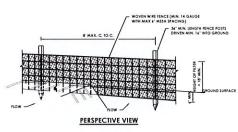

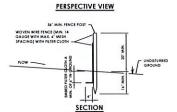



#### CONSTRUCTION SPECIFICATIONS


## SILT FENCE

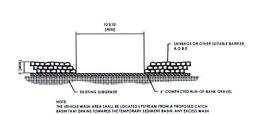

## TEMPORARY INLET PROTECTION DETAIL

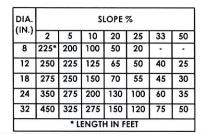

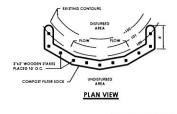

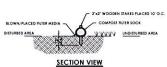

PROFILE

PLAN VIEW

2. LENGTH - NOT LESS THAN 50 FEET (EXCEPT ON A SINGLE RESIDENCE LOT WHERE A 30 FOOT M.


WHEN WASHING IS REQUIRED, IT SHALL BE DONE ON AN AREA STABILIZED WITH STONE AND W APPROVED SEDIMENT TRAPPING DEVICE.

WIDTH - TWELEVE (12) FOOT MINIMUM, BUT NOT LESS THAN THE FULL WIDTH AT POINTS TWENTY-FOUR (24) FOOT IF SINGLE ENTRANCE TO SITE.

5. GEOTEXTILE - WILL BE PLACED OVER THE ENTIRE AREA PRIOR TO PLACING OF STONE SURFACE WATER - ALL SURFACE WATER FLOWING OR DIVERTED TOWARD CONSTRUCTION ACCESS SHATHE ENTRANCE. IF PIPING IS IMPRACTIVAL, A MOUNTABLE BERM WITH 5% SLOPES WILL BE PERMITTED.

## COMPOST FILTER SOCK

1. STONE SIZE - USE 1-4 INCH STONE, OR RECLA

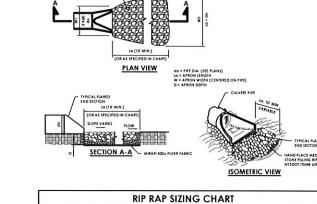


RIP RAP SIZING CHART				
PIPE DIA.	W1 - MINIMUM	W2 - MINIMUM	La - MINIMUM	D - MINIMUM
12	3.	11'	10	13.5
18"	4.5	11.5	10	13.5"
24"	·	12	10	13.5"
34"	*	12.5	10	13.5

NOTES:


1. d = 1.5 TIMES THE MAXIMUM STONE BUT NO LESS THAN 4".

2. INSTALL FILTER MIRAH 500x OR APPROVED EQUAL FILTER FABRIC BETWEEN RIP-RAP AND SUBGRAD


## RIP-RAP OUTLET PROTECTION DETAIL

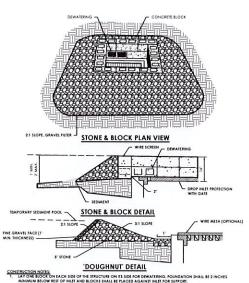

#### STABILIZED CONSTRUCTION ENTRANCE/DRIVEWAY

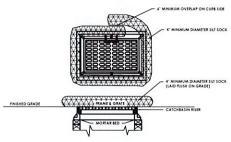

## **STONE & BLOCK DROP INLET PROTECTION**

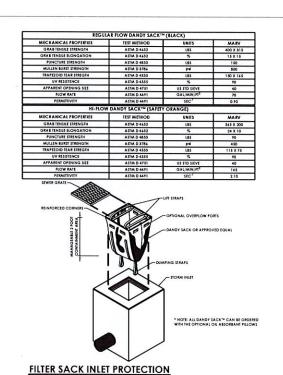



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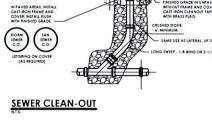
Drawing Title

**EROSION CONTROL NOTES** 

Drawing Number

301














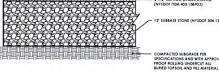

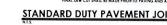

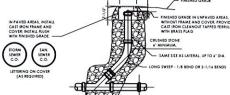





EXISTING PAVEMENT SHALL BE SAW CUT TO OBTAIN A STRAIGHT AND NEAT EDGE FOR PAVIN-FINAL SAW CUT SHALL BE MADE PRIOR TO PAVING AND AFTER SUBBASE STONE IS PLACED.


STANDARD DUTY PAVEMENT JOINT

TYPICAL DROP SECTION

**SANITARY SEWER AND LATERAL TRENCH** 


ALL DISTURBED AREAS SHALL BE MULCHED OR HAVE TURF ESTABLE

MANHOLE SECTION

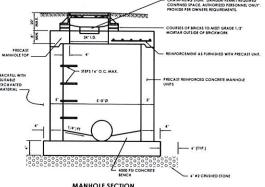

## STORM SEWER MANHOLE

MANHOLE FRAME

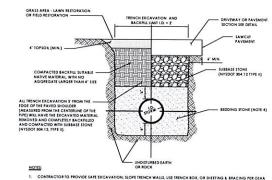

2. PAVEMENT BACKFILL AND RESTORATION REQUIREMENTS SHALL APPLY TO WORK PERFORMED UNDER PROPOSED I ALL WORK FOR STORM SEWER TRENCHING SHALL BE INCLUDED. THIS WORK INCLUDES, BUT IS NOT LIMITED TO TRENCHING, EXCAVATION AND ALL BACKFILL NO ADDITIONAL PAYMENTS WILL BE MADE FOR BACKFILL.

DOING STONE MEETING NYSDOT 203.07 GRADED WITHIN THE FOLLOWING LIMITS:

SIEVE SIZE	PERCENT PASSING		
1 INCH	100		
1/4 INCH	35 TO 40		
#40	10 TO 25		

## STORM SEWER TRENCH

PROJECT INFORMATION Project Number

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**GRAHAM CORPORATION** 

**CPL | Architecture Engineering Planning** 255 Woodcliff Drive, Suite 200

Fairport, NY 14450

CPLteam.com

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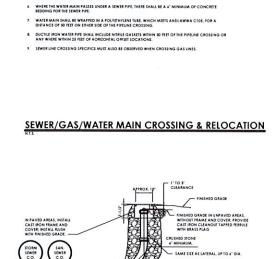
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Drawing Title

JTS

CONSTRUCTION DETAILS

Drawing Number



NOTES:

1. ONE STANDARD FULL LENGTH OF WATER MAIN (10 FEET MINIMUM) SHALL BE CENTERED UNDER THE SEWER, GAS FIRE AS THAT BOTH JOINTS WILL BE AS FAR ROOM THE SEWER, GAS FIRE AS POSSIBLE.

4. THERE SHALL BE 24" MINIMUM VERTICAL SEPARATION BETWEEN GAS AND WATER MAINS AND SHALL CONSIST OF SAND OR SELECT FILL.

WARNING TAPE, IN ACCORDANCE WITH A.P.W.A. UNIFORM COLOR CODE SHALL BE PLACED ABOVE UTILITY 12" BELOW GROUND, FOR A DISTANCE OF 25 FEET ON EITHER SIDE OF CROSSING.

2. THRUST RESTRAINT SHALL BE PROVIDED AT ALL BENDS. 3. THERE SHALL BE 18" MINIMUM VERTICAL SEPARATION BETWEEN

2'x2' CATCH BASIN

WATER TIGHT GROUT ALL CONN NON-SHRINK GROUT.



IN PARKING LOT

**CONCRETE COLLAR (CB)** 

6" LONG DOWEL CAST INTO CATCH BASIN EXTENSION WITH #4 BARS, 2 PER SIDE -

MIN. 10" THICK CONCRETE WITH 4"x4" 10 GA. WWF

FOR SELECT DEMO OF EXISTING STRUCTURE, SAWCUT BELOW KEY JOINT

PLAN VIEW

SECTION VIEW

AGAINST CURB

14 MAX. R.C.P., 1' MAX. ALL OHER PIPE MATERIAL FROM OUTSIDE FACE.


WIC COATS OF SEAGUARD NO. IS 32 YIEA OR BOUALOST BE DUBAL OR APPROVED FOUNDATION FOR


WIC COATS OF SHARE TO LOW OWNERS HEW. SLIST BY COATS NO COPPERS 1979 SERVICE BLACK OR

WICH COATS OF SHARE TO LOW OWNERS HE SLIST BY COATS OF LOWER SHARE TO SHARE THE SERVICE BLACK OR

WILLIAM SHARE SHARE SHARE AND SHAREST COMPONENS TO SALTAK CHAP WITH FLERES JOHN SLALES.

AL RIES JOHE SHALL BE RIESER FING GASELIS COUNTAINMENT OF THE STATE OF RECT, WITH SIELE RIG JOHNS. FOR COLD WOUTHER OF JOHNSON COMMENDED HE SELL SHELL RESIDENCE FOR RECT, WITH SIELE RIG JOHNS. FOR ALL DIRES FRESH PRESIDENCE FOR ALL DIRES FRESH FRE

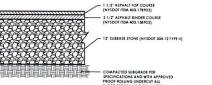


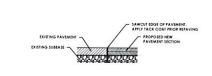


MINIMUM AREA OF BEARING FACE OF CONCRETE THRUST BLOCK (IN SQ. FT.) BLOCKS TO BE POURED AGAINST

UNDISTURBED SOIL						
PIPE SIZE	90° BEND	45° BEND	22-1/2° BEND	11-1/4° BEND	TEE/TS&V	PLUG
47,47		3	3	3	5	5
8-	10	4	3	3	8	
12"	19	7	4	3	14	16
14"	24	13	7	3	19	19
16"	27	13	8	4	36	34
24"	28	15.7		4	47	47

NOTES: 1. BLOCK HEIGHT (h) SHOULD BE EQUAL TO OR LESS THAN ONE-HALF THE TOTAL DEPTH TO THE BOTTOM OF THE BLOCK, (HT), BUT NOT LESS THAN PIPE DIAMETER (D).

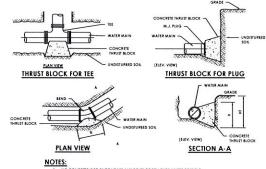


#### HORIZONTAL THRUST BLOCK

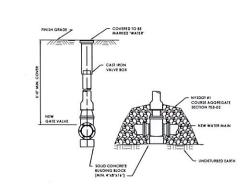


VERTICAL THRUST BLOCK


#### FIELD/LAWN AREA TYPICAL TRENCH WATER MAIN GATE VALVE

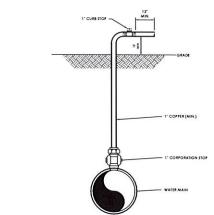


#### TEMPORARY DISINFECTION/BLOW-OFF/SAMPLING TAP

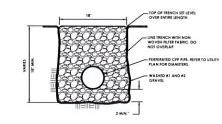

#### FRENCH DRAIN

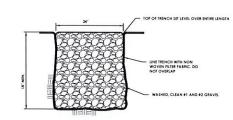

STONE DIAPHRAGM

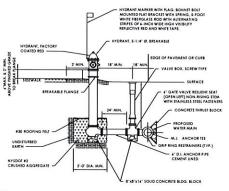

#### PERPENDICULAR FIRE HYDRANT ASSEMBLY



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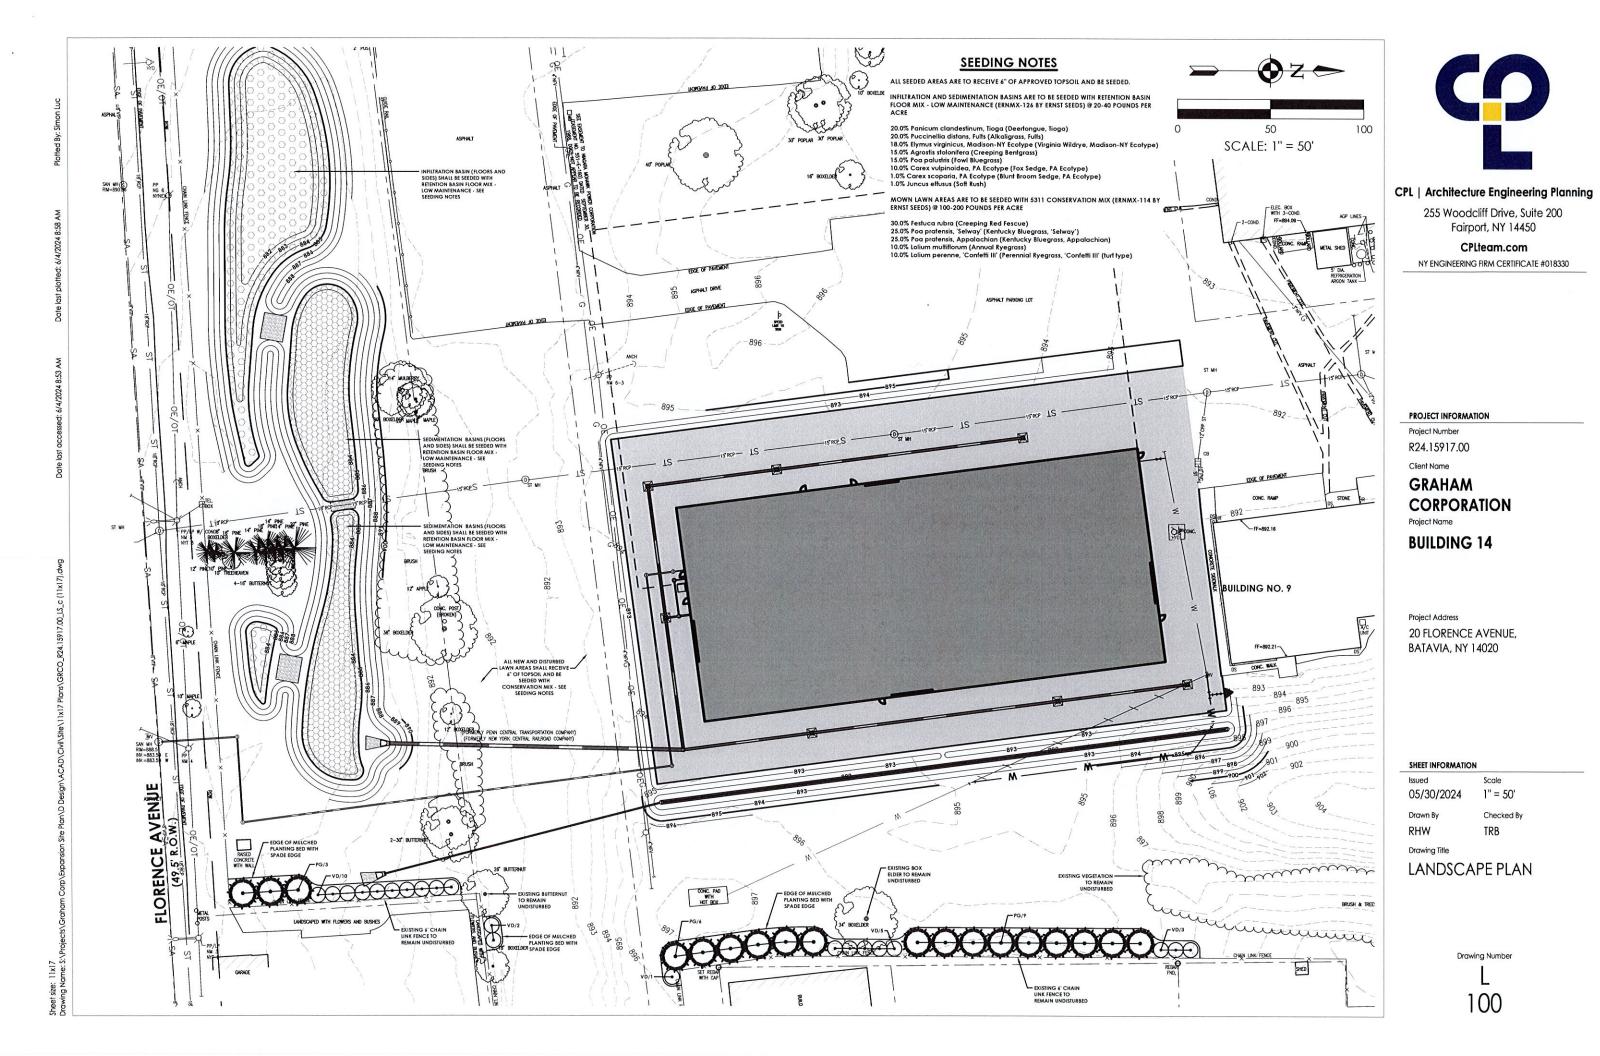
TRB

Checked By

Drawing Title

**CONSTRUCTION DETAILS** 








REMOVE SOIL AND ROOTS ABOVE ROOT COLLAR SHAVE ROOT BALL ROOT COLLAR - REMOVE EXCESS SOIL REMOVE EXCESS ROOTS NEW TOP OF ROOT BALL -ROOT FLARE SHOULD BE VISIBLE AT TOP OF ROOT


> SHAVE PERIMETER OF ROOT BALL A MAXIMUM OF 2" THICK TO REMOVE **ALL ROOTS GROWING** ON THE PERIPHERY

ROOT TIPS EXPOSED AT PERIPHERY OF ROOT BALL - ALL ROOTS GROWING AROUND PERIPHERY ARE

REMOVE DEFECTS



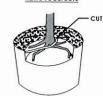

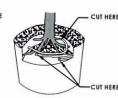


REMOVE STRUCTURAL ROOTS WHICH WRAP THE ROOT COLLAR AND/OR ARE GROWING OVER OTHER STRUCTURAL ROOTS BY CUTTING THEM (PARALLEL TO THE TRUNK) JUST BEFORE THEY MAKE AN ABRUPT TURN

NOTES:


- 1. ALL PLANTS ARE REJECTABLE UNLESS THEY UNDERGO RECOMMENDED CORRECTION.
- 2. SMALL ROOTS (¼" OR LESS) ON THE PERIPHERY OF THE ROOT BALL ARE COMMON WITH CONTAINER PLANT PRODUCTION. THESE SMALL ROOTS ARE NOT DEFINED AS DEFECTS BUT SHOULD BE ADDRESSED AT THE TIME OF
- 3. SHAVING TO BE DONE USING A SHARP BLADE OR HAND SAW ELIMINATING NO MORE THAN NEEDED TO REMOVE ALL ROOTS ON THE PERIPHERY OF THE ROOT BALL.
- 4. SHAVING CAN BE PERFORMED JUST PRIOR TO PLANTING OR AFTER PLACING THE ROOT BALL IN THE HOLE.

### **ROOT CORRECTION FOR CONTAINER PLANTS**

STEP 1 - REMOVE SOIL AND ROOTS OVER THE ROOT COLLAR

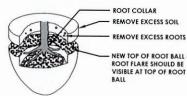


STEP 2 - REMOVE DEFECTS

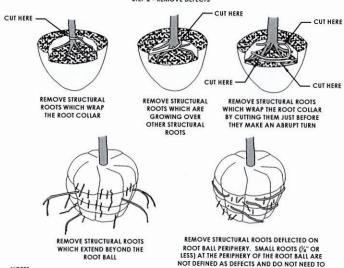

- 1. ALL TREES ARE REJECTABLE UNLESS THEY UNDERGO RECOMMENDED CORRECTION.
- 2. ADJUST HOLE DEPTH TO ACCOUNT FOR THE REMOVAL OF EXCESS SOIL AND ROOTS OVER THE COLLAR AND ACHIEVE APPROPRIATE ELEVATION OF ROOT FLARE.


## **ROOT CORRECTION FOR BALLED AND BURLAPPED PLANTS**

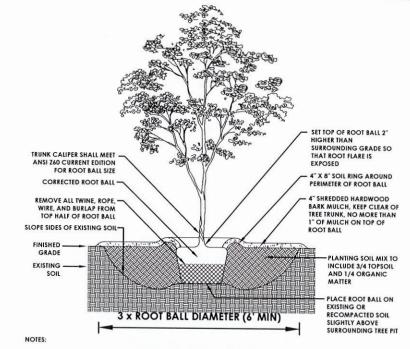

- 1. DO NOT HEAVILY PRUNE TREES AT PLANTING. PRUNE ONLY CROSSOVER LIMBS, CO-DOMINANT LEADERS, AND BROKEN OR DEAD BRANCHES. SOME INTERIOR TWIGS AND LATERAL BRANCHES MAY BE PRUNED, HOWEVER, DO NOT REMOVE THE TERMINAL BUDS OF BRANCHES THAT EXTEND TO THE EDGE OF THE CROWN.
- 2. PRIOR TO MULCHING, LIGHTLY TAMP SOIL AROUND THE ROOT BALL IN 6" LIFTS TO BRACE TREE. DO NOT OVER COMPACT. WHEN PLANTING HOLE HAS BEEN BACKFILLED POUR WATER AROUND THE ROOT BALL TO SETTLE THE SOIL.
- 3. STAKE TREES ONLY UPON THE APPROVAL OF THE LANDSCAPE ARCHITECT.
- 4. WRAP TREE TRUNKS ONLY UPON THE APPROVAL OF THE LANDSCAPE ARCHITECT.
- 5. MARK THE NORTH SIDE OF THE TREE AT THE NURSERY, AND ROTATE TREE TO FACE NORTH AT THE SITE WHENEVER
- 6. ROOT BALLS SHALL BE CORRECTED PRIOR TO PLANTING PER THE ROOT BALL CORRECTION DETAILS.
- 7. WHERE TREES ARE TO BE INSTALLED IN AREAS OF FORMER PAVEMENT, A 20' X 20' AREA (AT EACH TREE) IS TO BE PREPARED PER THE DETAIL "SURFACE PREPARATION FOR TREES AND SHRUBS IN PAVED AREAS" PRIOR TO INSTALLING THE TREE PIT PER THIS DETAIL.

8. WHERE TREES ARE TO BE INSTALLED IN AREAS THAT WERE NEVER PAVED, THE TREE IS TO BE INSTALLED PER THIS DETAIL WITH NO ADDITIONAL SURFACE PREPARATION REQUIRED.



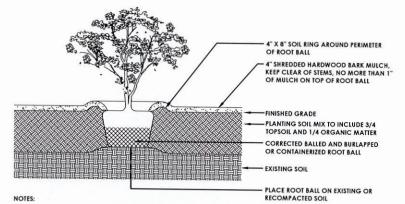

1. DO NOT HEAVILY PRUNE SHRUBS AT PLANTING. PRUNE ONLY CROSSOVER LIMBS, CO-DOMINANT LEADERS, AND BROKEN OR DEAD BRANCHES. SOME INTERIOR TWIGS AND LATERAL BRANCHES MAY BE PRUNED, HOWEVER, DO NOT REMOVE THE TERMINAL BUDS OF BRANCHES THAT EXTEND TO THE EDGE OF THE CROWN.

- 2. PRIOR TO MULCHING, LIGHTLY TAMP SOIL AROUND THE ROOT BALL IN 6" LIFTS TO BRACE SHRUB. DO NOT OVER COMPACT. WHEN PLANTING HOLE HAS BEEN BACKFILLED POUR WATER AROUND THE ROOT MASS TO SETTLE THE SOIL.
- 3. ROOT BALLS OF BOTH CONTAINERIZED AND BALLED AND BURLAPPED PLANTS SHALL BE CORRECTED PRIOR TO PLANTING PER THE ROOT BALL CORRECTION DETAILS.

SHRUB



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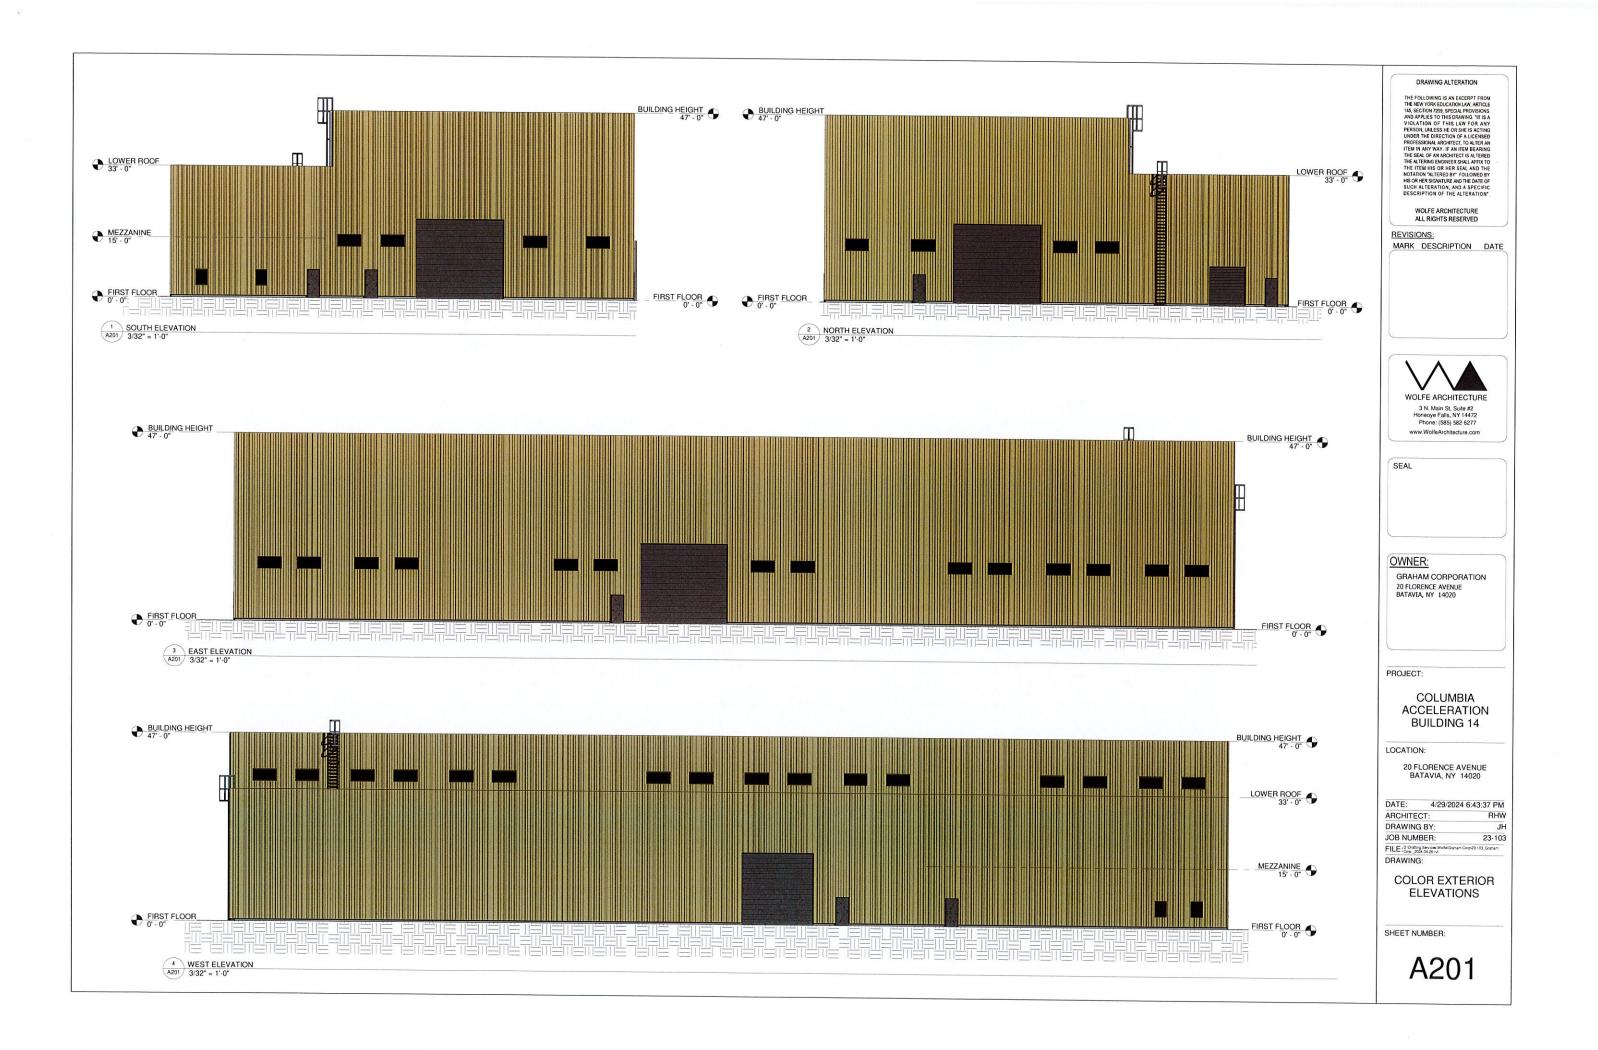
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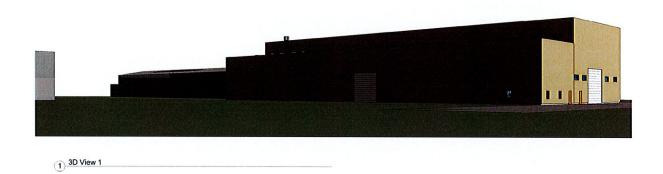
LANDSCAPE DETAILS

Scale


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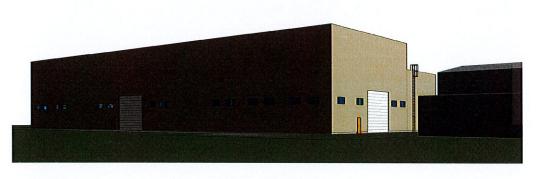











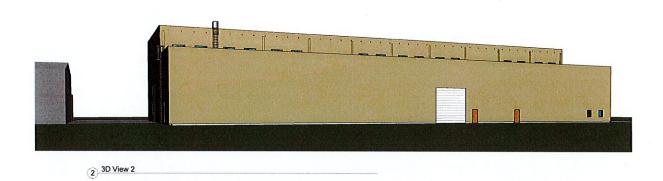

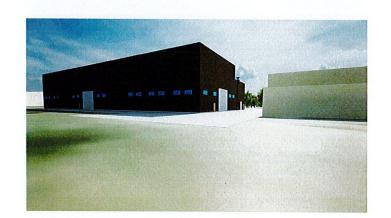

#### DRAWING ALTERATION

THE FOLLOWING IS AN EXCERT FROM THE NEW YORK EDUCATION LAW, ARTICLE 14S, SECTION 7293, SPECIAL PROVISIONS AND APPLES TO THIS GRAWING "THE A YIOLATION OF THIS LAW FOR AS AT YIOLATION OF THIS LAW FOR AN INTERPRETATION OF THE SEAT OF THE ALTERNO BEGINERS USALL AFFET TO THE SEAT AND THE NOTATION THEREO BY "FOLLOWED BY HIS OR HER SIGNATURE AND THE DATE OF SUCH ALTERNO THE AND THE DATE OF SUCH ALTERNO THE ALTERNO THE APPLICATION, AND A SPECIFIC DESCRIPTION OF THE ALTERNATION.

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3 N. Main St, Suite #2 Honeoye Falls, NY 14472 Phone: (585) 582-6277 www.WolfeArchitecture.com

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OWNER:

GRAHAM CORPORATION 20 FLORENCE AVENUE BATAVIA, NY 14020

PROJECT:

COLUMBIA ACCELERATION BUILDING 14

LOCATION:

20 FLORENCE AVENUE BATAVIA, NY 14020

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